KALAMAZOO COUNTY LAND BANK AUTHORITY EAST MAIN COMMERCIAL CORRIDOR BUILDING C



350 East Michigan Avenue Suite #415 Kalamazoo Michigan 49007 Phone (269) 381-3357 Fax (269) 381-2944

Landscape Architecture Parks & Recreation Campus & Institutional Planning Camp Planning & Design

KALAMAZOO COUNTY LAND BANK AUTHORITY

1523 RIVERVIEW DRIVE KALAMAZOO. MICHIGAN 49004 269-216-9667 TELE

ARCHITECT:

269-270-3331 TELE

OWNER/CLIENT:

INFORM ARCHITECTURE 401 EAST MICHIGAN AVENUE, SUITE 100 KALAMAZOO, MICHIGAN 49007

LANDSCAPE ARCHITECT: O'BOYLE COWELL BLALOCK & ASSOCIATES, INC.

350 EAST MICHIGAN AVENUE, SUITE #415 KALAMAZOO, MICHIGAN 49007 269-381-3357 TELE 269-381-2944 FAX



BE 24"X36" WHEN PLOTTED SCALE(S) INDICATED AND GRAPHIC QUALITY MAY NOT BE ACCURATE FOR ANY OTHER SIZES. Issued For:

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PRE-SPR	09-03-21
ZBA SUBMITTAL	12/16/21
FINAL SPR SUBMITTAL	06/10/22

Project:

East Main Commercial Corridor

Kalamazoo, Michigan

Sheet Title

1601 East Main St. **Cover Sheet**

Job No.


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KALAMAZOO, MICHIGAN

Site Plan Review City of Kalamazoo 06-10-2022

LOCATION MAP



NOTES:

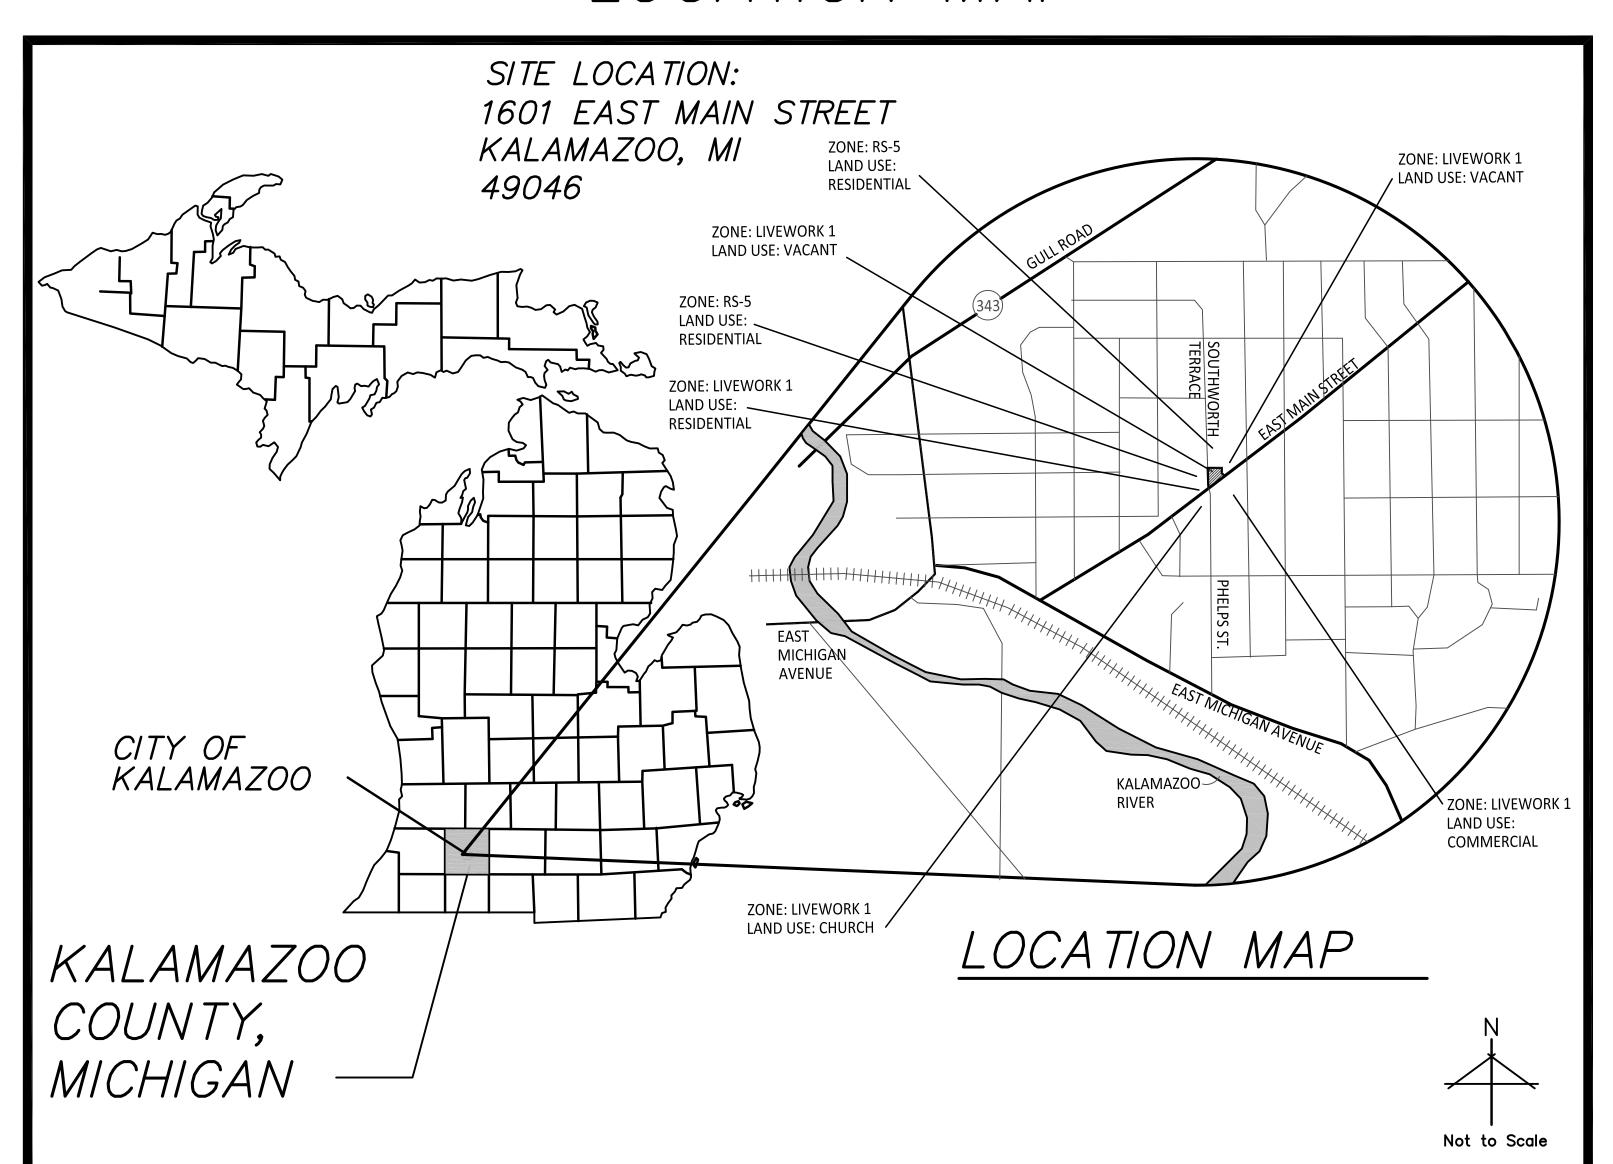- 1) Except where other wise indicated on the plans or in the proposal and supplemental specifications or special provisions contained herein, all materials and workmanship shall be in accordance with Michigan Department of Transportation Standard Specifications for Construction, 1996 Edition.
- 2) Call Miss Dig, 1-800-482-7171 three working days, excluding Saturday, Sunday and holidays, before starting your project.

SITE PLAN REVIEW NOTES

- 1. Project Address: 1601 East Main Street, Kalamazoo, Michigan 490048.
- 2. Property Identification Number: 06-14-255-030 3. Proposed Use: Mixed Use — Commercial and Residential

SHEET INDEX

COVER SHEET

LAYOUT PLAN

DETAILS

DETAILS

C4.1

DEMOLITION PLAN

LANDSCAPE PLAN

A3.1C EXTERIOR ELEVATIONS

A3.2C EXTERIOR ELEVATIONS

A3.3C EXTERIOR ELEVATIONS

TOPOGRAPHIC SURVEY

GRADING AND SESC PLAN

ELECTRICAL SITE LIGHTING PLAN

OVERALL WATER AND SEWER PLAN

WATER MAIN PLAN AND PROFILES

WATER MAIN PLAN AND PROFILES


FIRST FLOOR PLAN — BUILDING C


A1.2C SECOND FLOOR PLAN - BUILDING C


- 4. Property Owner: Kalamazoo County Land Bank Authority
- 5. Project Zoning: LW-1, Live Work 1
- 6. Legal Description: Commencing on the west line of HAZARDS SUBDIVISION OF SECTION 14, Liber 5 of Plats Page 21, at its intersection with the north line of East Main Stree; thence North 94.6ft along said west line; thence West 114ft to the east line of Southworth Terrace; thence South 186ft along the east line of Southworth Terrace to the north line of East Main St; thence Northeasterly 143.6ft along the north line of East Main Street to the west line of HAZARDS SUBDIVISION OF SECTION 14 and the point of beginning. 7. Front Yard Setback: 0'-0" Rear Yard Setback: 10'-0" Side Yard Setback: 0'-0"
- 8. Existing Off Street Parking Spaces: 0 spaces
- 9. Parking Spaces Required: Thirteen (13) parking spaces
- 10. Proposed Off-Street Parking Spaces: Thirteen (13) parking spaces 11. Gross Overall Site Area: 16,057 sf (0.37 acres)
- 12. Gross Area of Earth Change: 16.057 sf (0.37 acres)
- 13. Gross Area of Building: (5,545) sf (0.13 acres) 14. Gross Usable Floor Area by Type:
- 1st Floor: (5,545) sf, (0.13 acres), Residential
- 1st Floor: (1,790) sf, (0.04 acres), Commercial/Retail/Office
- 2nd Floor: (3,755) sf (0.09 acres), Residential
- 15. Existing Impervious Area: 0 sf (0 acres) 16. Proposed Impervious Area: 11,786 sf (0.27 acres)
- 17. Existing Area of Open Space: 16,057 sf (0.37 acres)
- 18. Proposed Area of Open Space: 3,951 sf (0.09 acres)
- 19. Parcel is not located within a National or Local Historic Register District.
- 20. Number of Residential Units by Type: Six (6) R-2 Type Units 21. This project site is located in the Eastside Neighborhood
- 22. This project is located within 10—Year Time of Capture Wellhead Protection Zoning.
- 23. This project is identified as "Neighborhood Edge" and "Neighborhood Node" on the 2025 Future Land Use Plan.
- 24. This project is not located within a Natural Features Protection Overlay District.
- 25. Area of Regulated Wetlands: 0 sf (0.0 acres)
- 26. Estimated Number of Vehicle Trips per Day: Per the ITE Trip Generation (10th Edition) formula for Land Use Code: 220 (Multi-Family Housing Low-Rise): 6 Dwelling Units \times 0.56 multiplier for weekday totals = 3.36 vehicle trips per day. Estimated Number of Vehicle Trips per Day: Per the ITE Trip Generation (10th Edition) formula for Land Use Code: 936 (Coffee Shops without a Drive Through Window): 1,000 SF GFA x 36.31 multiplier for weekday totals: $1.79 \times 36.31 = 64.99$ vehicle trips
- 27. Number of Bike Racks Required and Provided: Four (4) Bicycle Spaces are required and two (2) Bicycle Racks will be provided.

BOUNDARY AND TOPOGRAPHIC SURVEY

IN THE NORTHEAST QUARTER OF SECTION 14, TOWNSHIP 2 SOUTH, RANGE 11 WEST, CITY OF KALAMAZOO, KALAMAZOO COUNTY, MICHIGAN

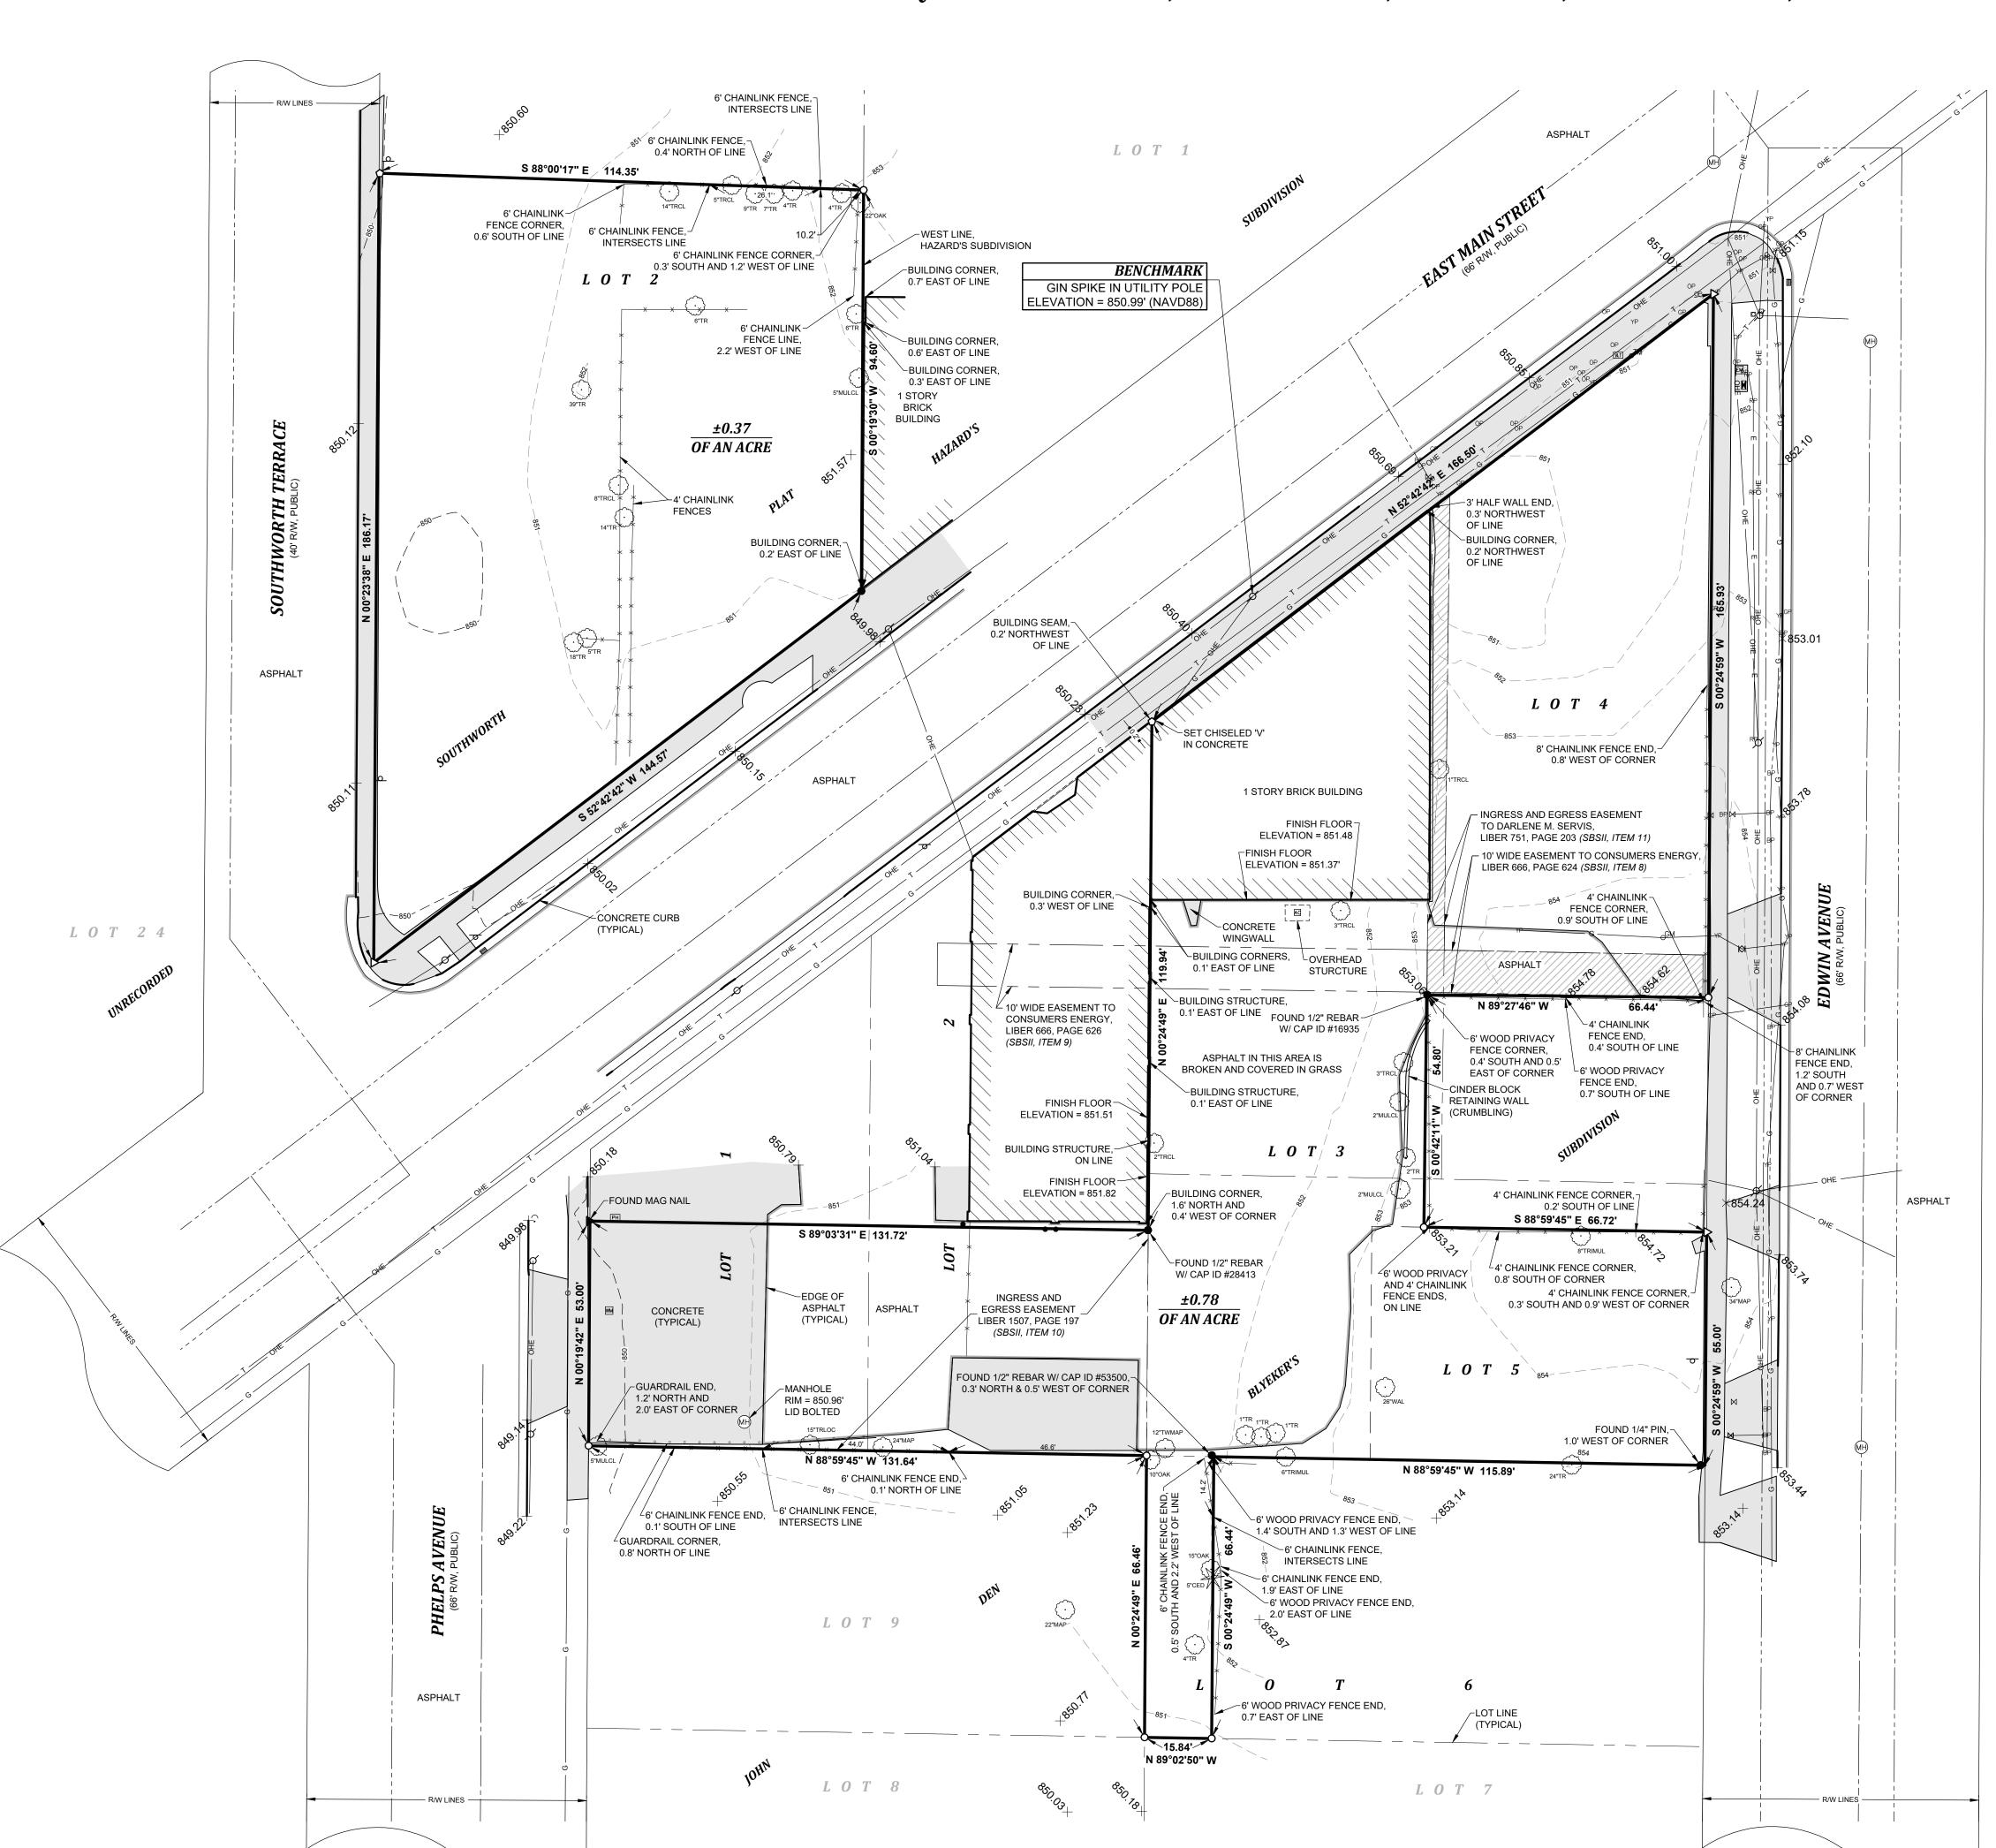

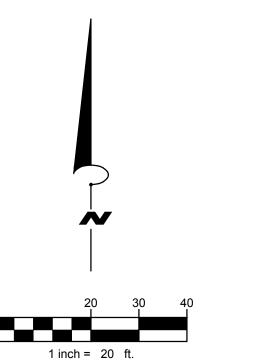

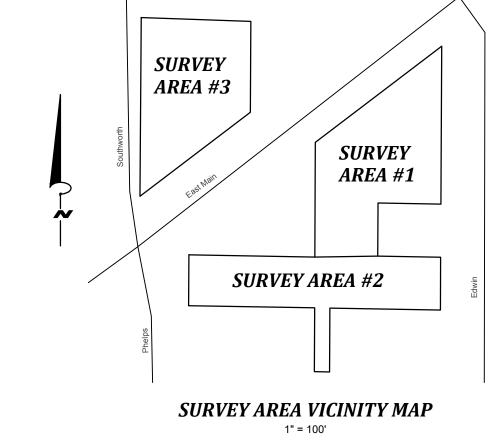

LEGAL DESCRIPTION PER EXHIBIT "A", COMMITMENT FOR TITLE INSURANCE PREPARED BY CHICAGO TITLE OF MICHIGAN, INC., COMMITMENT NO. 391131102NBU, COMMITMENT DATE SEPTEMBER 25, 2020:

THE SOUTH 53 FEET OF LOTS 1 AND 2, LOT 3, LOT 4 EXCEPT THE SOUTH 44 FEET THEREOF; LOT 5 EXCEPT THE NORTH 11 FEET OF THE EAST 66 FEET OF LOT 5. AND THE WEST 15.84 FEET OF LOTS 6 AND 7, OF JOHN DEN BLYEKER'S SUB., ACCORDING TO THE PLAT THEREOF AS RECORDED IN LIBER 5 OF PLATS, PAGE 12. KALAMAZOO COUNTY RECORDS.

ALSO, PART OF THE NORTHEAST QUARTER OF SECTION 14, TOWN 2 SOUTH, RANGE 11 WEST, BEING MORE PARTICULARLY DESCRIBED AS:


21, KALAMAZOO COUNTY RECORDS; AT ITS INTERSECTION WITH THE NORTH LINE OF EAST MAIN STREET; THENCE NORTH 94.6 FEET ALONG SAID WEST LINE; THENCE WEST 114 FEET TO THE EAST LINE OF SOUTHWORTH TERRACE; THENCE SOUTH 186 FEET ALONG THE EAST LINE OF SOUTHWORTH TERRACE TO THE NORTH LINE OF EAST MAIN STREET; THENCE NORTHEASTERLY 143.6 FEET ALONG THE NORTH LINE OF EAST MAIN STREET TO THE WEST LINE OF SAID HAZARDS SUBDIVISION OF SECTION 14 TO THE POINT OF BEGINNING.

SUBJECT TO ANY AND ALL EASEMENTS AND RESTRICTIONS OF RECORD, OR OTHERWISE.

SUBJECT TO ANY FACTS THAT MAY BE DISCLOSED IN A FULL AND ACCURATE TITLE SEARCH.

BEARINGS ARE RELATED TO THE MICHIGAN STATE PLANE COORDINATE SYSTEM, SOUTH ZONE.

THE RELATIVE POSITIONAL PRECISION OF EACH CORNER IS WITHIN THE LIMITS ACCEPTED BY THE PRACTICE OF PROFESSIONAL SURVEYING IN MICHIGAN.

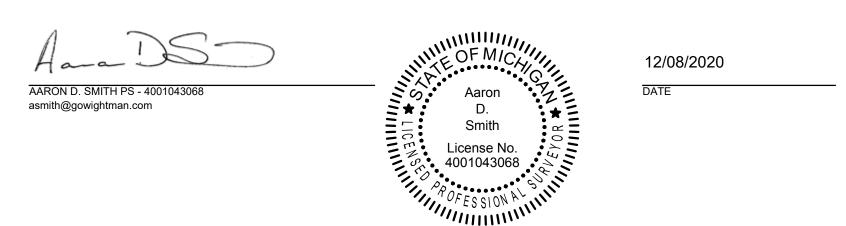

LEGEND

	<u>LEGEND</u>		
0	= SET 1/2" REBAR W/ CAP ID #43068	B₽	= BLUE PAINT
\triangleright	= SET MAG NAIL	GP	= GREEN PAINT
۵	= SET CHISELED MARKING	MH	= MANHOLE
•	= FOUND IRON (AS NOTED)		= CURB INLET
•	= FOUND MAG NAIL	PH	= PAY PHONE (DISCONNECTED)
Ø	= UTILITY POLE	0	= SIGN
(•	= GUY WIRE	•	= POST
E	= ELECTRIC METER	×854.70'	= SPOT ELEVATION
AC	= AIR CONDITIONER		= CONIFEROUS TREE
RP	= RED PAINT	CED	= CEDAR
⊙™	= TELEPHONE MARKER POST	\odot	= DECIDUOUS TREE
□	= TELEPHONE PEDESTAL	MAP	= MAPLE
	= COMMUNICATION CLOSET	MULCL	= MULBERRY CLUSTER
	= COMMUNICATION CABINET	OAK	= OAK
VLT	= COMMUNICATION VAULT	TRLOC	= TRIPLE LOCUST
OР	= ORANGE PAINT	TRMUL	= TRIPLE MULBERRY
ĸ	= GAS VALVE	TR	= TREE
₀GM	= GAS MARKER POST	TRCL	= TREE CLUSTER
ΥP	= YELLOW PAINT	TWMAP	= TWIN MAPLE
M	= WATER VALVE	WAL	= WALNUT
wM	= WATER METER		
	NAVD88 = NORTH AMERI	CAN VER	TICAL DATUM OF 1988
	OHE = OVERHEAD UT	TILITY LINE	ES
	E = APPROXIMATE	BURIED	ELECTRIC LOCATION
	= APPROXIMATE	SANITAR	RY SEWER LOCATION
	= APPROXIMATE	WATER I	LOCATION
	G = APPROXIMATE	BURIED	GAS LOCATION
	T = APPROXIMATE	BURIED	TELEPHONE LOCATION

NOTES:

BLANKET EASEMENT FOR INGRESS AND EGRESS OVER THE SOUTH 53 FEET OF LOTS 1 AND 2, JOHN DEN BLEYKER SUBDIVISION. LIBER 5, PAGE 12, KALAMAZOO COUNTY RECORDS.

THE UNDERGROUND UTILITIES SHOWN, HAVE BEEN LOCATED FROM FIELD SURVEY INFORMATION AND EXISTING DRAWINGS. THE SURVEYOR MAKES NO GUARANTEES THAT THE UNDERGROUND UTILITIES SHOWN COMPRISE ALL SUCH UTILITIES IN THE AREA, EITHER IN-SERVICE OR ABANDONED. THE SURVEYOR FURTHER DOES NOT WARRANT THAT THE UNDERGROUND UTILITIES ARE IN THE EXACT LOCATION INDICATED ALTHOUGH THE SURVEYOR DOES CERTIFY THAT THEY ARE LOCATED AS ACCURATELY AS POSSIBLE FROM THE INFORMATION AVAILABLE. THE SURVEYOR HAS NOT PHYSICALLY LOCATED THE UNDERGROUND UTILITIES.



BENTON HARBOR 269.927.0100

KALAMAZOO

269.327.3532

ALLEGAN

248.791.1371

269.673.8465 ROYAL OAK

www.gowightman.com

AARON D. SMITH

PROJECT ADDRESS:

EAST MAIN

PS - 4001043068

POCKET PARK
KALAMAZOO, MI 49048

KALAMAZOO
COUNTY LAND
BANK AUTHORITY
1523 RIVERVIEW DRIVE, SUITE A

KALAMAZOO, MI 49004

REVISIONS
C:\Users\aeubanks\Desktop\204340 Top

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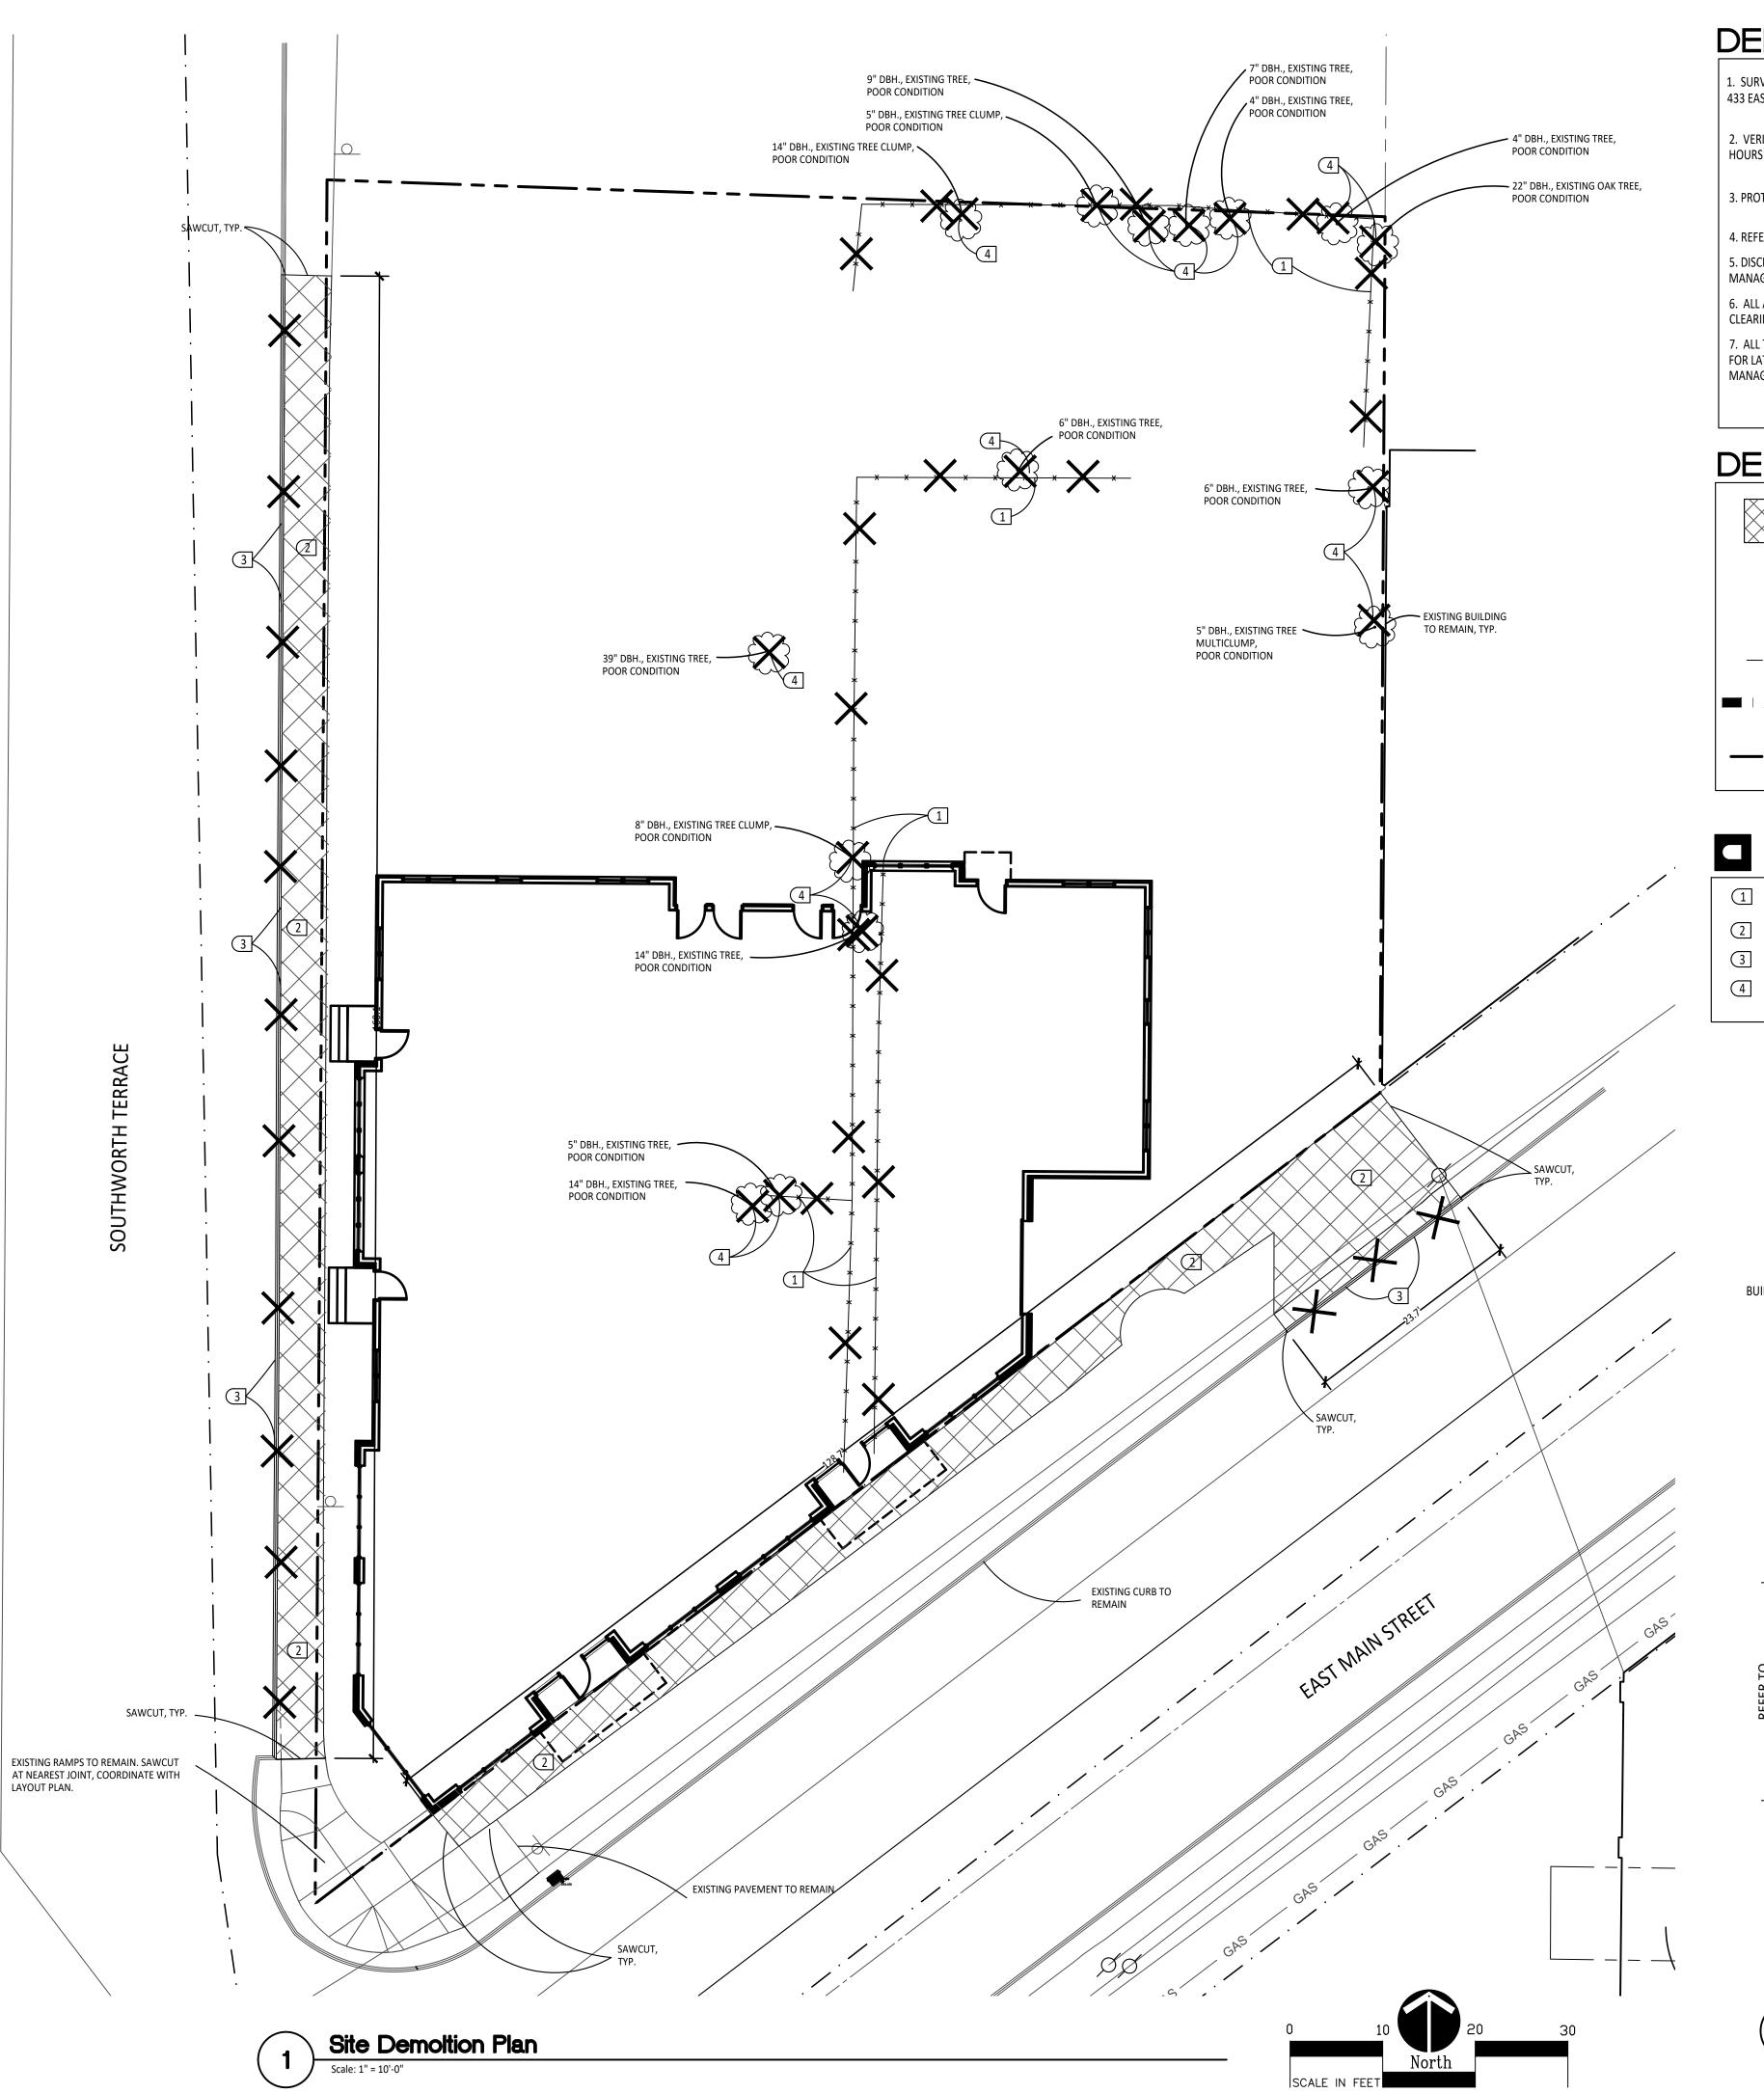
DATE: DECEMBER 8, 2020

SCALE: AS NOTED

DRAWN BY: ACE
CHECKED BY: GDH

BOUNDARY AND TOPOGRAPHIC SURVEY

JOB No. 204340



DEMOLITION NOTES:

1. SURVEY OF EXISTING CONDITIONS PROVIDED BY WIGHTMAN & ASSOCIATES, INC., 433 EAST RANSOM STREET, KALAMAZOO, MICHIGAN 49007, (269)327-3532

2. VERIFY LOCATIONS OF ALL BELOW GRADE UTILITIES PRIOR TO BEGINNING WORK. 72 HOURS BEFORE YOU DIG CALL "MISS DIG" AT 1-800-482-7171.

3. PROTECT ALL TREES & EXISTING FEATURES TO REMAIN AS SPECIFIED.


4. REFER TO LAYOUT PLAN FOR LIMITS OF WORK.

5. DISCREPANCIES BETWEEN SITE AND PLANS SHOULD BE REPORTED TO THE PROJECT MANAGER IMMEDIATELY.

6. ALL AREAS OF TREE CLEARING SHALL BE STAKED FOR ARCHITECT'S APPROVAL PRIOR TO


7. ALL TOPSOIL AND EXCESS FILL MATERIAL SHALL BE STOCKPILED ON SITE SEPARATELY FOR LATER RE-USE. LOCATE STOCKPILES IN AREAS AS DIRECTED BY CONSTRUCTION MANAGER AND PROTECT FROM EFFECTS OF EROSION.

DEMOLITION LEGEND:

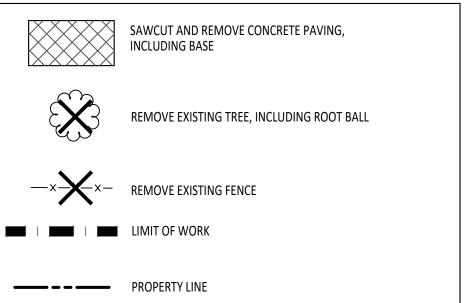


SITE DEMOLITION KEY

- REMOVE EXISTING FENCING, INCLUDING CONCRETE FOOTINGS
- 2 SAWCUT AND REMOVE EXISTING CONCRETE PAVING INCLUDING SUB-BASE.
- 3 SAWCUT AND REMOVE EXISTING CURB (AND GUTTER).
- 4 REMOVE EXISTING TREE INCLUDING ALL ROOT SYSTEMS.

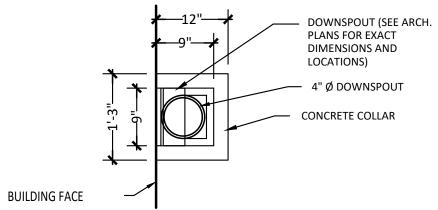

PLAN VIEW

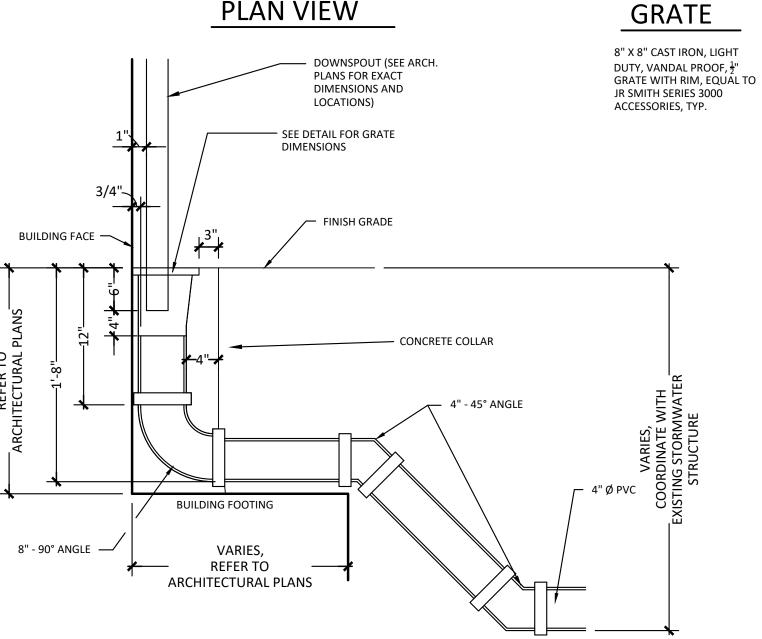

X-SECTION

Downspout Collector Detail



350 East Michigan Avenue Suite #415 Kalamazoo Michigan 49007 Phone (269) 381-3357

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IN•FORM architecture

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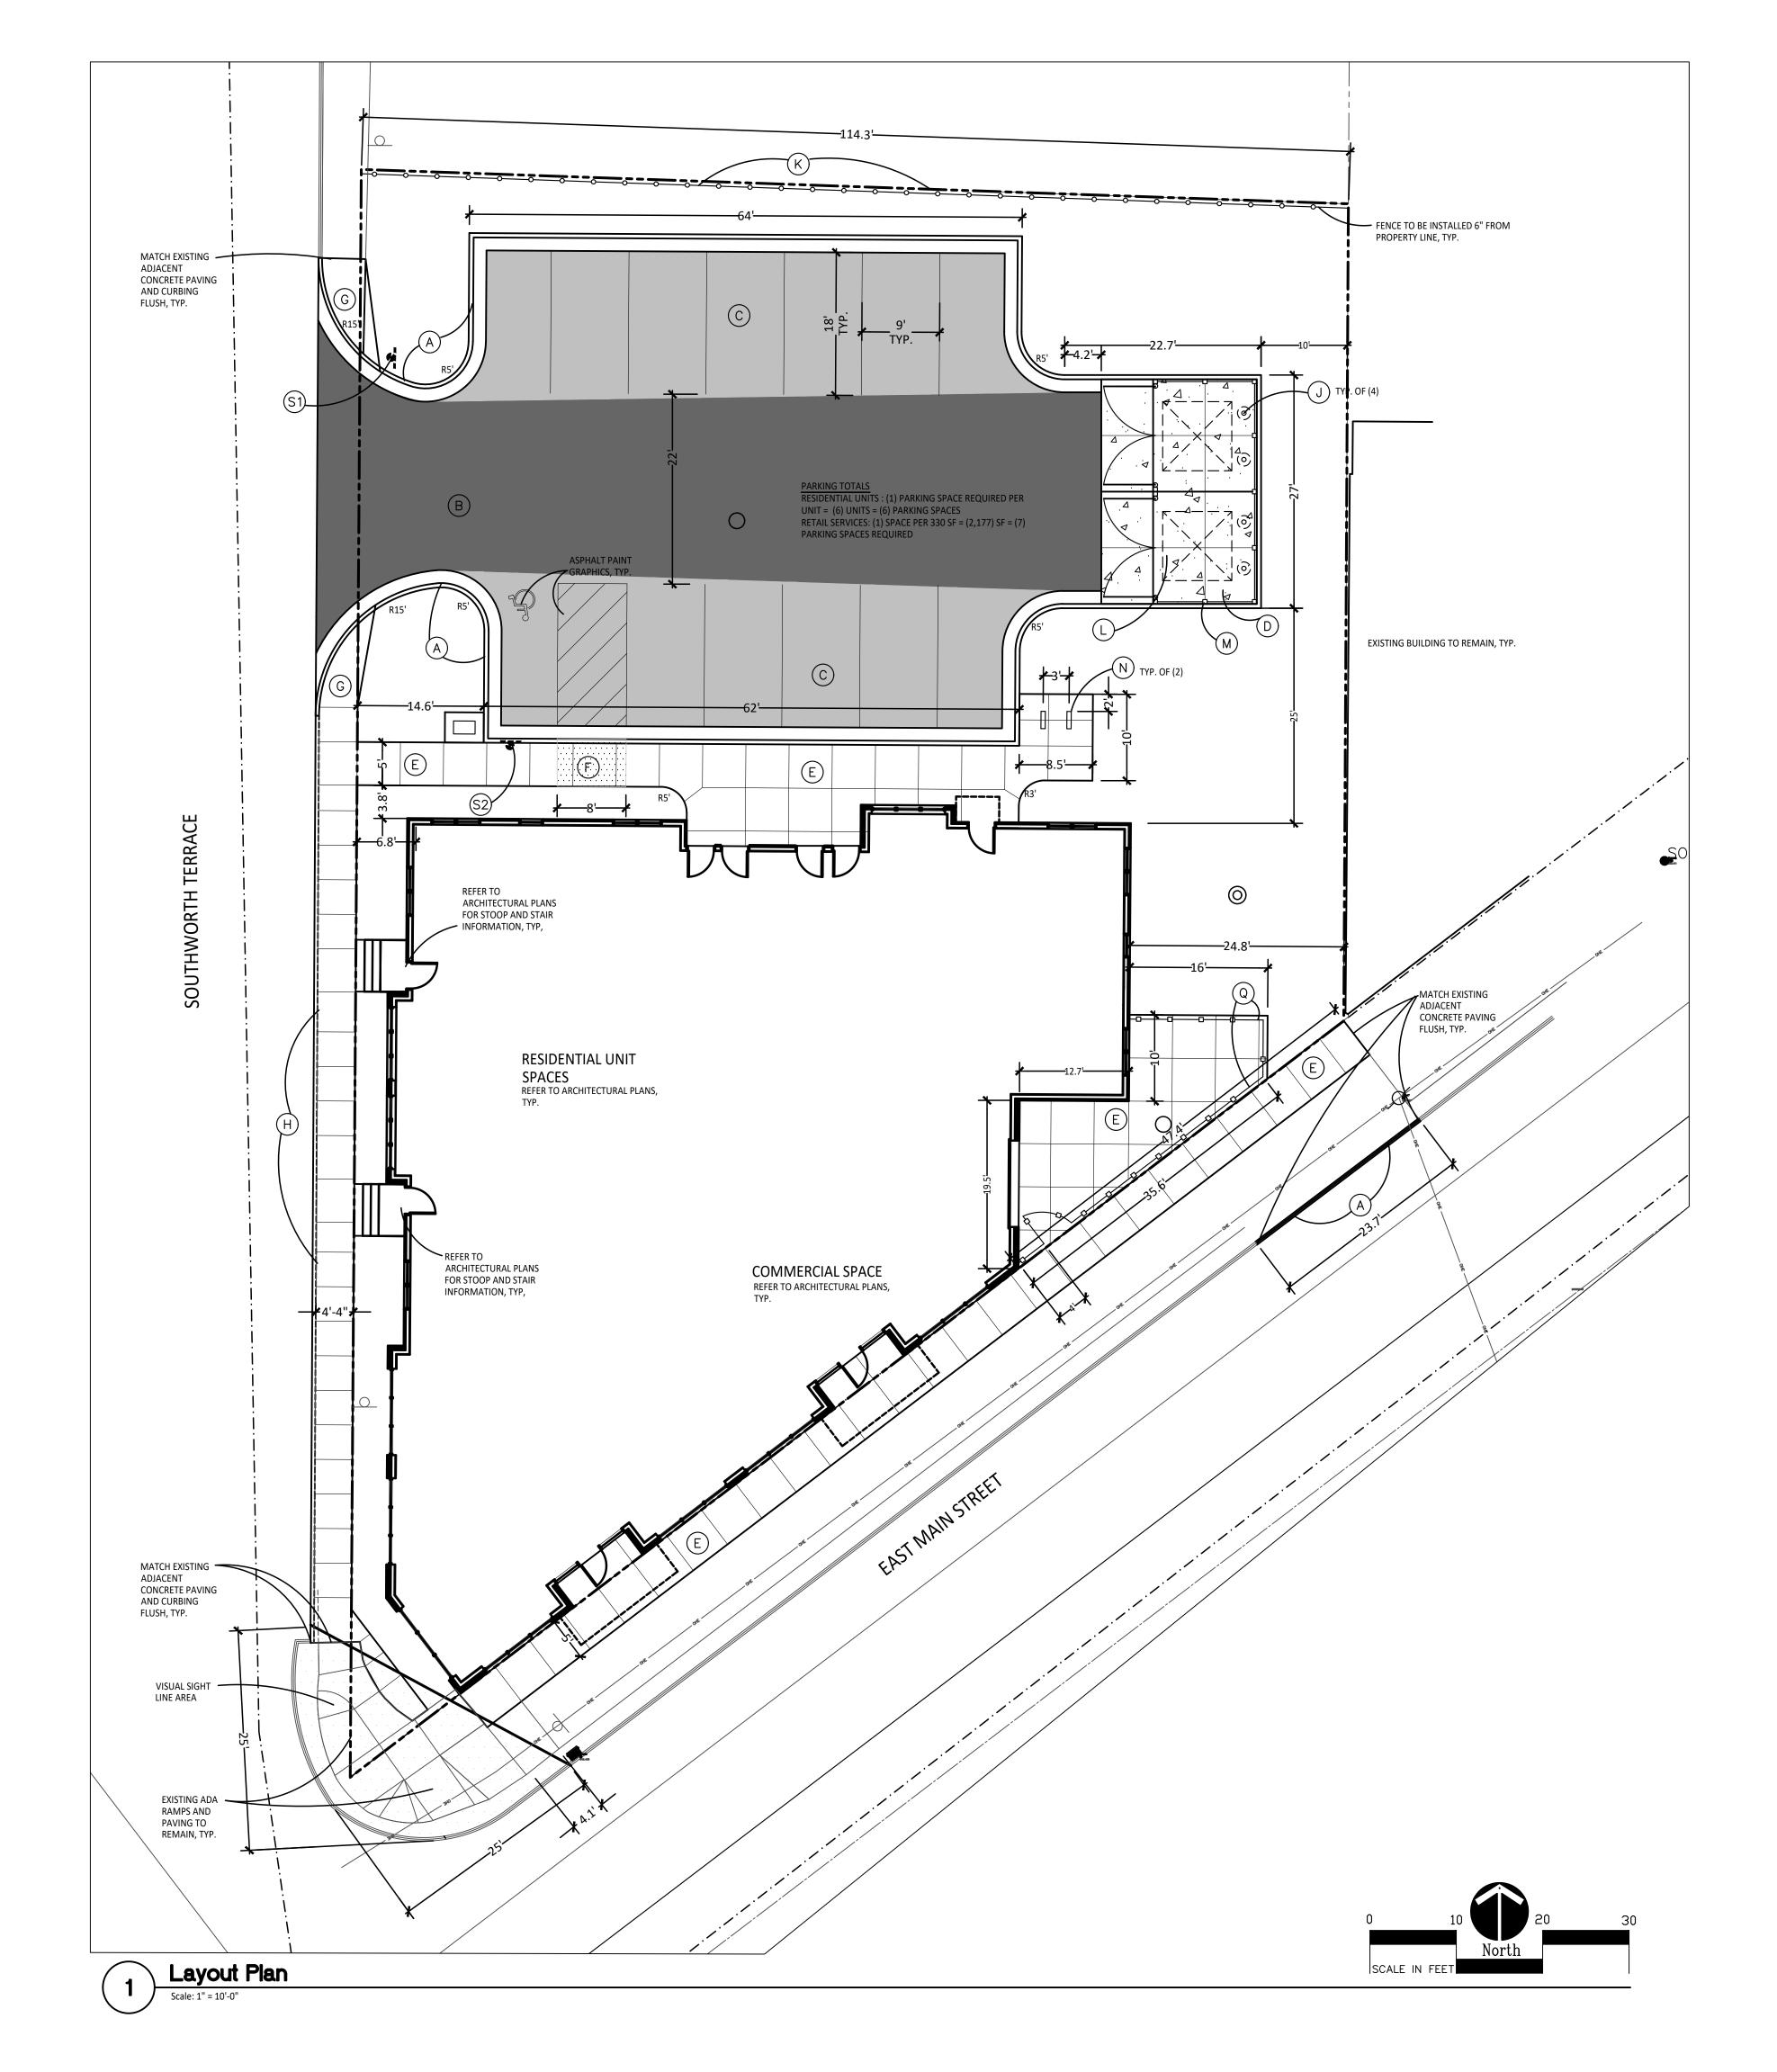
1601 East Main St.

Demolition Plan

21003

drawing date CHECK SET 05.19.2022

sheet number



LAYOUT NOTES:

1. SURVEY OF EXISTING CONDITIONS PROVIDED BY WIGHTMAN & ASSOCIATES, INC., 433 EAST RANSOM STREET, KALAMAZOO, MICHIGAN 49007 (269)327-3532

2. PAVEMENT DIMENSIONS AND RADII ARE TO EDGE OF PAVEMENT OR BACK OF CURB.

3. DISCREPANCIES BETWEEN SITE AND PLANS SHOULD BE REPORTED TO THE PROJECT MANAGER IMMEDIATELY.

4. VERIFY LOCATIONS OF ALL BELOW GRADE UTILITIES PRIOR TO BEGINNING WORK. 72 HOURS BEFORE YOU DIG CALL "MISS DIG" AT 1-800-482-7171.

5. PROVIDE BARRIER FREE PARKING SIGNS FOR ALL BARRIER FREE PARKING SPACES. ALL SIGNS TO COMPLY WITH THE MDOT MICHIGAN MANUAL OF UNIFORM TRAFFIC CONTROL DEVICES.

6. SITE LAYOUT POINTS SHOULD BE ESTABLISHED AND PROTECTED FOR FUTURE SITE

BARRIER-FREE NOTES

BARRIER-FREE PARKING AND ACCESSIBLE ROUTE(S) MUST COMPLY WITH THE AMERICANS WITH DISABILITIES ACT AND MICHIGAN BARRIER-FREE CODE REQUIREMENTS, INCLUDING BUT NOT LIMITED TO THE FOLLOWING:

- 1:50 (2%) MAXIMUM CROSS-SLOPE ON ACCESSIBLE ROUTE. - NO CHANGES IN LEVEL GREATER THAN 1/2" ALONG ACCESSIBLE

- 1:20 (5%) MAXIMUM LONGITUDINAL SLOPE ON ACCESSIBLE ROUTE (EXCEPT WHERE RAMPS ARE PROVIDED). - 1:50 (2%) MAXIMUM SLOPE (IN ANY DIRECTION) IN B.F. PARKING AND ACCESS AISLES.

DDODOOED EEATUDEO LEOEND.

SYMBOL	DESCRIPTION	
B	BITUMINOUS PAVING- HEAVY DUTY	
©	BITUMINOUS PAVING- MODERATE DUTY	
D A	6" REINFORCED CONCRETE PAVING	
	PROPOSED CONCRETE CURB AND GUTTER	
	PROPOSED INTEGRAL WALK AND CURB	
	PAVEMENT FLUSH WITH BIT. PAVEMENT / BARRI RAMP - TYPE I	ER FREE
	BARRIER FREE RAMP - TYPE II	
· · · · · · · · · · · · · · · · · · ·	6' WOOD SCREEN FENCE	
	3' ORNAMENTAL METAL FENCE	
KEY DESC	RIPTION	DETAIL
$\overline{\frown}$	RIPTION ICRETE CURB AND GUTTER	DETAIL 5 /C4.0
A CON		
A CON	ICRETE CURB AND GUTTER	5 /C4.0
A CON B HEA	ICRETE CURB AND GUTTER VY DUTY BITUMINOUS PAVING	5 /C4.0 1 /C4.0
A CON B HEA' C MOD D 6" R	ICRETE CURB AND GUTTER VY DUTY BITUMINOUS PAVING DERATE DUTY BITUMINOUS PAVING	5 /C4.0 1 /C4.0 2 /C4.0
A CON B HEA C MOD 6" R E CON	ICRETE CURB AND GUTTER VY DUTY BITUMINOUS PAVING DERATE DUTY BITUMINOUS PAVING EINFORCED CONCRETE PAVING	5 /C4.0 1 /C4.0 2 /C4.0 4 /C4.0
A CON B HEA C MOD D 6" RI E CON BAR	ICRETE CURB AND GUTTER VY DUTY BITUMINOUS PAVING DERATE DUTY BITUMINOUS PAVING EINFORCED CONCRETE PAVING ICRETE WALK	5 /C4.0 1 /C4.0 2 /C4.0 4 /C4.0 3 /C4.0
A CON B HEA' C MOD G" RI E CON BARI G BARI	ICRETE CURB AND GUTTER VY DUTY BITUMINOUS PAVING DERATE DUTY BITUMINOUS PAVING EINFORCED CONCRETE PAVING ICRETE WALK RIER FREE RAMP TYPE 1	5 /C4.0 1 /C4.0 2 /C4.0 4 /C4.0 3 /C4.0 6 /C4.0
A CON B HEA C MOD C G" R E CON F BAR G BAR H INTE	ICRETE CURB AND GUTTER VY DUTY BITUMINOUS PAVING DERATE DUTY BITUMINOUS PAVING EINFORCED CONCRETE PAVING ICRETE WALK RIER FREE RAMP TYPE 1 RIER FREE RAMP TYPE II	5 /C4.0 1 /C4.0 2 /C4.0 4 /C4.0 3 /C4.0 6 /C4.0 7 /C4.0
A CON B HEA' C MOD D 6" RI E CON F BARI G BARI J STEE	ICRETE CURB AND GUTTER VY DUTY BITUMINOUS PAVING DERATE DUTY BITUMINOUS PAVING EINFORCED CONCRETE PAVING ICRETE WALK RIER FREE RAMP TYPE 1 RIER FREE RAMP TYPE II EGRAL CONCRETE WALK AND CURB	5 /C4.0 1 /C4.0 2 /C4.0 4 /C4.0 3 /C4.0 6 /C4.0 7 /C4.0 10 /C4.0
A CON B HEA' C MOD D 6" RI E CON F BARI G BARI J STEE	ICRETE CURB AND GUTTER VY DUTY BITUMINOUS PAVING DERATE DUTY BITUMINOUS PAVING EINFORCED CONCRETE PAVING ICRETE WALK RIER FREE RAMP TYPE 1 RIER FREE RAMP TYPE II EGRAL CONCRETE WALK AND CURB EL GUARD POST	5 /C4.0 1 /C4.0 2 /C4.0 4 /C4.0 3 /C4.0 6 /C4.0 7 /C4.0 10 /C4.0 1 /C4.1
A CON B HEA' C MOD D 6" RI E CON F BARI G BARI H INTE	ICRETE CURB AND GUTTER VY DUTY BITUMINOUS PAVING DERATE DUTY BITUMINOUS PAVING EINFORCED CONCRETE PAVING ICRETE WALK RIER FREE RAMP TYPE 1 RIER FREE RAMP TYPE II EGRAL CONCRETE WALK AND CURB EL GUARD POST IGH WOOD SCREEN FENCING	5 /C4.0 1 /C4.0 2 /C4.0 4 /C4.0 3 /C4.0 6 /C4.0 7 /C4.0 10 /C4.0 1 /C4.1 3 /C4.1
A CON B HEA' C MOD G"RI E CON F BAR G BAR H INTE	ICRETE CURB AND GUTTER VY DUTY BITUMINOUS PAVING DERATE DUTY BITUMINOUS PAVING EINFORCED CONCRETE PAVING ICRETE WALK RIER FREE RAMP TYPE 1 RIER FREE RAMP TYPE II EGRAL CONCRETE WALK AND CURB EL GUARD POST IGH WOOD SCREEN FENCING IBLE DUMPSTER LAYOUT	5 /C4.0 1 /C4.0 2 /C4.0 4 /C4.0 3 /C4.0 6 /C4.0 7 /C4.0 10 /C4.0 1 /C4.1 3 /C4.1
A CON B HEA' C MOD G"RI E CON F BARI G BARI H INTE	ICRETE CURB AND GUTTER VY DUTY BITUMINOUS PAVING DERATE DUTY BITUMINOUS PAVING EINFORCED CONCRETE PAVING ICRETE WALK RIER FREE RAMP TYPE 1 RIER FREE RAMP TYPE II EGRAL CONCRETE WALK AND CURB EL GUARD POST IGH WOOD SCREEN FENCING IBLE DUMPSTER LAYOUT MPSTER ENCLOSURE SCREEN FENCING E RACK	5 /C4.0 1 /C4.0 2 /C4.0 4 /C4.0 3 /C4.0 6 /C4.0 7 /C4.0 10 /C4.0 1 /C4.1 3 /C4.1 2 /C4.1 4 /C4.1
A CON B HEA' C MOD G" RI E CON F BARI G BARI H INTE K G' HI L DOU N BIKE P N/A	ICRETE CURB AND GUTTER VY DUTY BITUMINOUS PAVING DERATE DUTY BITUMINOUS PAVING EINFORCED CONCRETE PAVING ICRETE WALK RIER FREE RAMP TYPE 1 RIER FREE RAMP TYPE II EGRAL CONCRETE WALK AND CURB EL GUARD POST IGH WOOD SCREEN FENCING IBLE DUMPSTER LAYOUT MPSTER ENCLOSURE SCREEN FENCING E RACK	5 /C4.0 1 /C4.0 2 /C4.0 4 /C4.0 3 /C4.0 6 /C4.0 7 /C4.0 10 /C4.0 1 /C4.1 3 /C4.1 2 /C4.1
A CON B HEA' C MOD G" R E CON F BAR G BAR H INTE K G' HI L DOU N BIKE P N/A 3' HI	ICRETE CURB AND GUTTER VY DUTY BITUMINOUS PAVING DERATE DUTY BITUMINOUS PAVING EINFORCED CONCRETE PAVING ICRETE WALK RIER FREE RAMP TYPE 1 EGRAL CONCRETE WALK AND CURB EL GUARD POST IGH WOOD SCREEN FENCING IBLE DUMPSTER LAYOUT MPSTER ENCLOSURE SCREEN FENCING E RACK	5 /C4.0 1 /C4.0 2 /C4.0 4 /C4.0 3 /C4.0 6 /C4.0 7 /C4.0 10 /C4.0 1 /C4.1 3 /C4.1 2 /C4.1 4 /C4.1 9 /C4.0
A CON B HEA' C MOD C G" RI E CON F BARI G BARI H INTE K G' HI L DOU M DUM N BIKE	CRETE CURB AND GUTTER VY DUTY BITUMINOUS PAVING DERATE DUTY BITUMINOUS PAVING EINFORCED CONCRETE PAVING ICRETE WALK RIER FREE RAMP TYPE 1 RIER FREE RAMP TYPE II EGRAL CONCRETE WALK AND CURB EL GUARD POST IGH WOOD SCREEN FENCING JBLE DUMPSTER LAYOUT MPSTER ENCLOSURE SCREEN FENCING I RACK IGH ORNAMENTAL METAL FENCE & GATE	5 /C4.0 1 /C4.0 2 /C4.0 4 /C4.0 3 /C4.0 6 /C4.0 7 /C4.0 10 /C4.0 1 /C4.1 3 /C4.1 2 /C4.1 4 /C4.1 9 /C4.0



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Landscape Architecture
Urban Planning Parks & Recreation Campus & Institutional Planning Camp Planning & Design IN-FORM architecture

01 e. michigan ave kalamazoo, mi 49007 69.270.3331 www.informarchitect.com

1601 East Main St. Layout Plan project number

FINAL SPR SUBMITTAL


21003

sheet name

drawing date **QAQC SET**

sheet number

06.10.2022

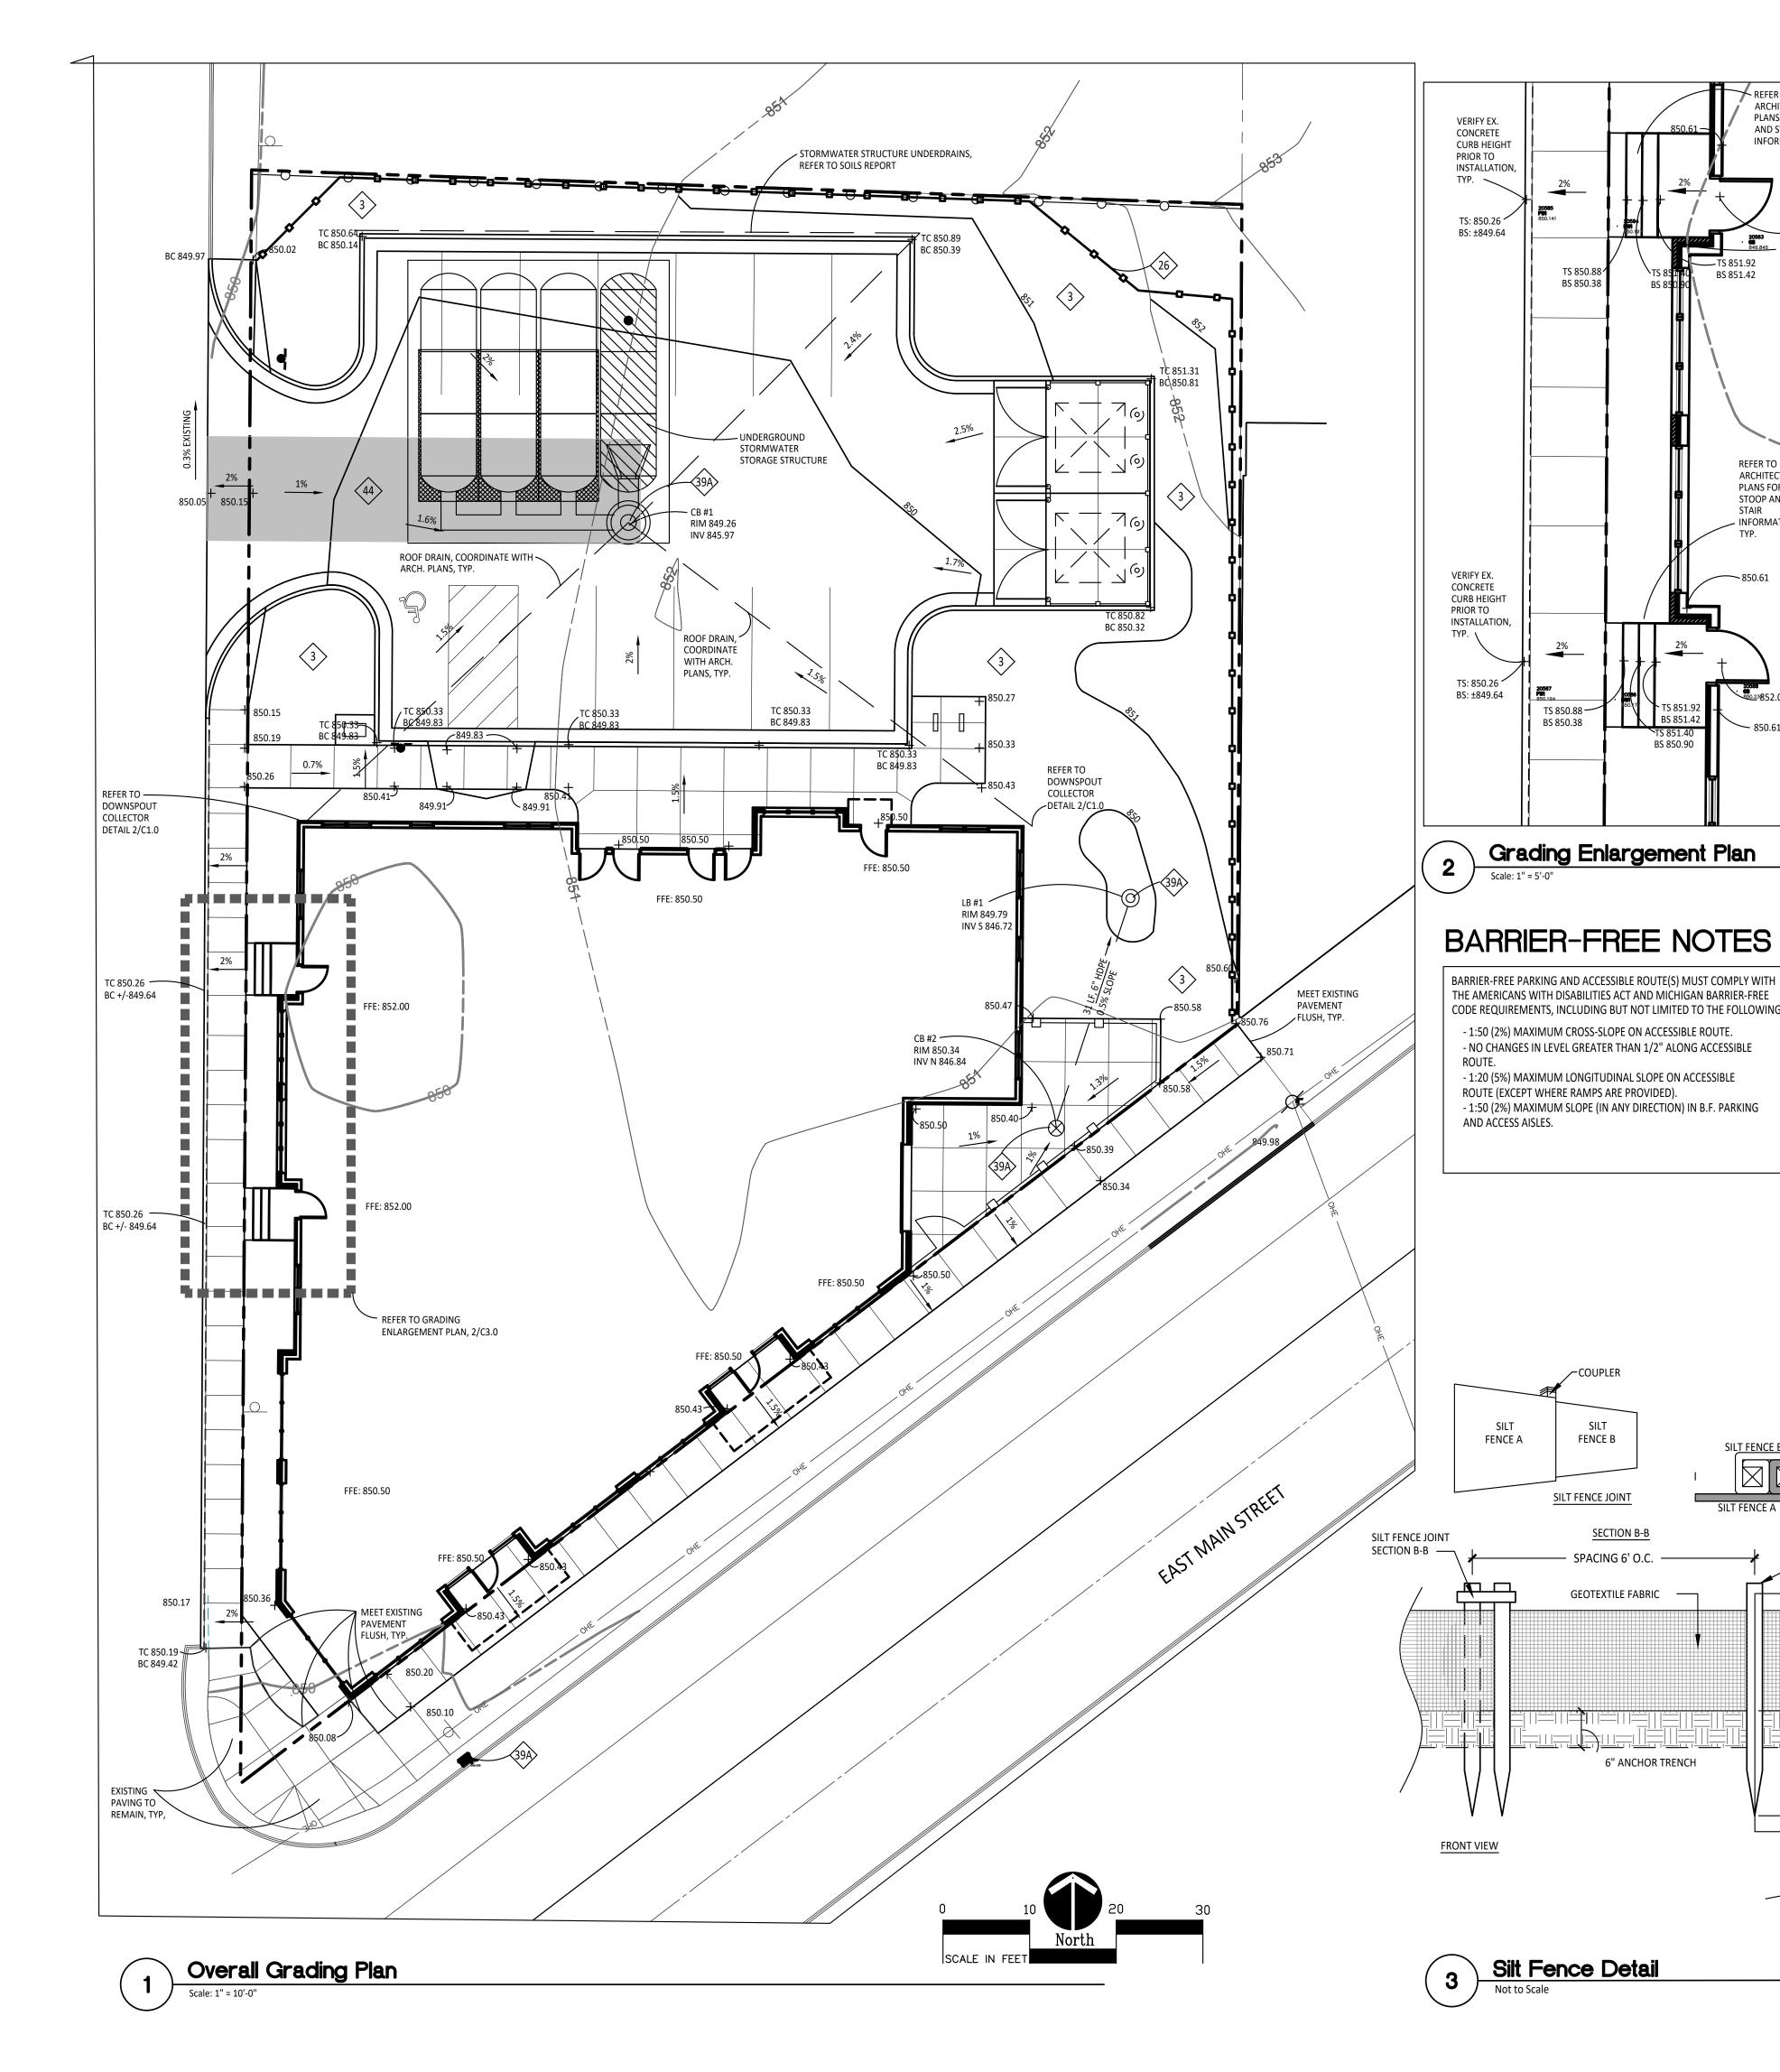

PROPOSED FEATURES LEGEND:

ARCHITECTURAL PLANS FOR STOOP

INFORMATION, TYP.

AND STAIR

REFER TO


PLANS FOR STOOP AND

INFORMATION

BS 851.42

BS 850.90

ARCHITECTURAL

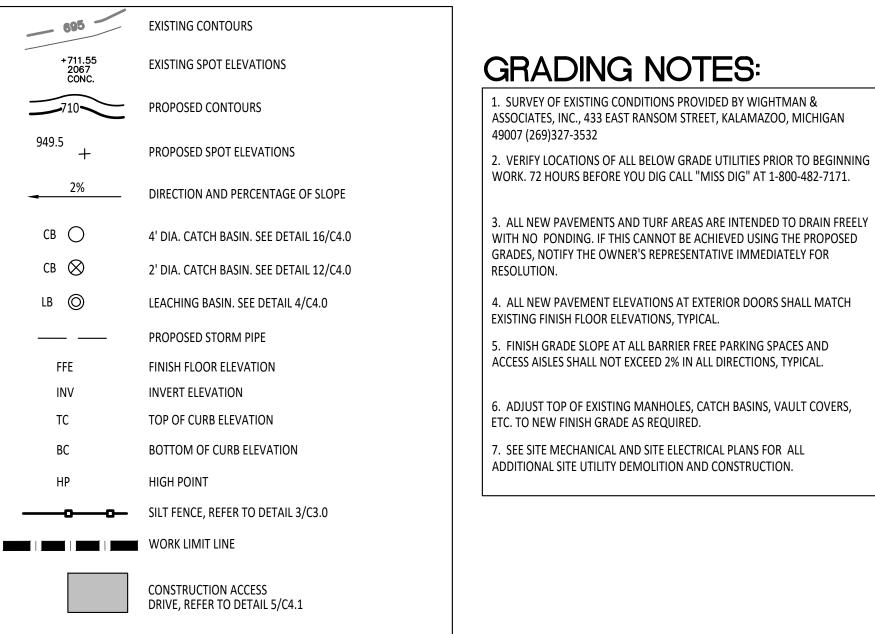

IMPORTANT NOTE

GENERAL EARTHWORK NOTE:

CUTS AND FILLS AT THIS SITE MAY OR MAY NOT BALANCE. IT IS THE CONTRACTOR'S VOLUME OF IMPORTED CLASS II SAND IN THE BASE BID PROPOSAL. IF EXCESS SOILS NEED TO BE SPOILED, THE CONTRACTOR SHALL INCLUDE HAULING AND SPOILING SOILS OFF SITE IN THE BASE BID PROPOSAL. NO CONTRACT COST ADJUSTMENTS WILL BE CONSIDERED FOR EARTHWORK REQUIRED TO BALANCE THE SITE.

EROSION CONTROL TIMELINE

ITEM	DESCRIPTION	APPROXIMATE TIME FRAME	NOTES:
1.	INSTALL SILT FENCING / PERIMETER EROSION CONTROL	FALL '22	1. CONTRACTOR SHALL MONITOR AND MAINTAIN
2.	STRIP & STOCKPILE TOPSOIL	FALL '22	ALL EROSION CONTROL DEVICES THROUGHOUT
3.	INSTALL STORM SEWER STRUCTURES AND PIPING	FALL '22	THE CONSTRUCTION PERIOD.
4.	INSTALL INLET SEDIMENT FILTERS AT CATCH BASINS	FALL '22	
5.	INSTALL PAVEMENT SUB-BASE	FALL '22	2. ADDITIONAL EROSION CONTROL MEASURES
6.	INSTALL TEMPORARY STABILIZATION SEEDING	SPRING '23	SHALL BE IMPLEMENTED AS REQUIRED TO MINIMIZE SILT LEAVING THE CONSTRUCTION SITE.
7.	INSTALL LEVELING COURSE OF PAVING	SPRING '23	
8.	INSTALL WEARING COURSE OF PAVING	SPRING '23	
9.	FINISH GRADE AND SEED / STABILIZE ALL AREAS	FALL '23	

EROSION CONTROL REQUIREMENTS:


ALL CONSTRUCTION SHALL COMPLY WITH THE SOIL EROSION AND SEDIMENTATION CONTROL ACT (P.A. 347 OF 1972, AS AMENDED) AS ADMINISTERED BY TOWNSHIP AND COUNTY. THE FOLLOWING EROSION CONTROL DEVICES ARE REFERENCED IN THE STANDARD EROSION CONTROL HANDBOOK PUBLISHED BY THE MICHIGAN DEPARTMENT OF TRANSPORTATION. (MDOT DRAWING R-96-C, 8-9-2001)

ALL TEMPORARY EROSION CONTROL DEVICES SHALL BE REMOVED AT THE END OF CONSTRUCTION. TEMPORARY EROSION CONTROL DEVICES SHOULD BE IN PLACE PRIOR TO EXCAVATION, TO THE EXTENT POSSIBLE.

KEY	DESCRIPTION	TEMPORARY / PERMANENT	KEY	DESCRIPTION	TEMPORARY / PERMANENT
3	PERMANENT/TEMPORARY SEEDING	Р	39A>	INLET PROTECTION FABRIC DROP	Т
26	GEOTEXTILE SILT FENCE	Т	44	GRAVEL ACCESS APPROACH	Т



			RM SEWER SYSTEM UCTURE SUMMARY			
PROPOSED STRUCTURE #	DIAMETER	RIM TYPE	RIM ELEVATION AT FLOW LINE	INVERT ELEVATION	INVERT DIRECTION	COMMENTS
CB #1	2'	EJIW 1040 W M2	849.47	845.97	N/A	X
CB #2	2'	EJIW 1040 W M2	850.34	846.84	6" HDPE, N	
LB #1	2'	EJIW 1040 O2	850.10	846.72	6" HDPE S	

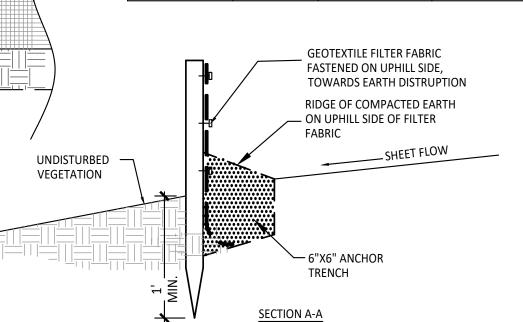

WRAPPED AROUND FENCE POST

FENCE POSTS DRIVEN INTO

- GROUND 1' MIN.



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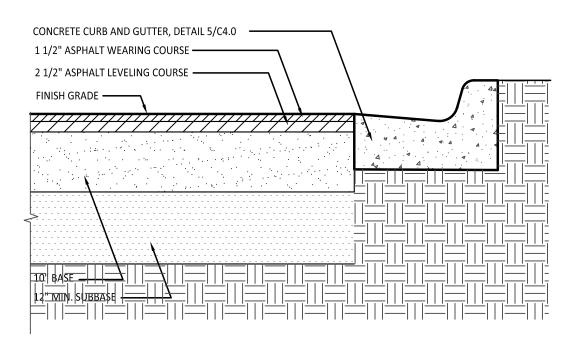
1601 East Main St.

Grading/SESC Plan project number


21003

drawing date **QAQC SET** 06.10.2022


sheet number




Section-Bituminous Pavement Heavy Duty Not to Scale

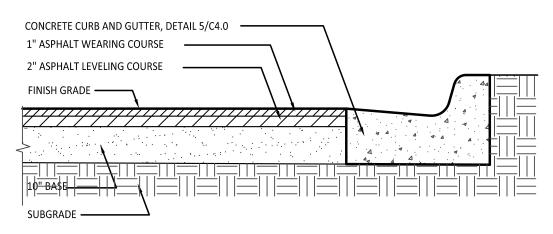


Section-Bituminous Pavement Moderate Duty Not to Scale

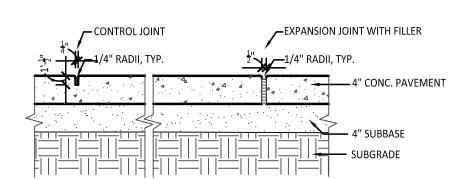

Section-Conc. Paving + Jointing Not To Scale

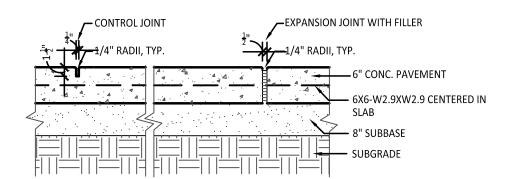

4 Section-6' Reinf. Conc. Pavement Not To Scale

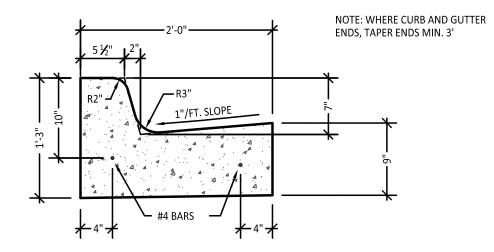



5 Curb + Gutter Detail




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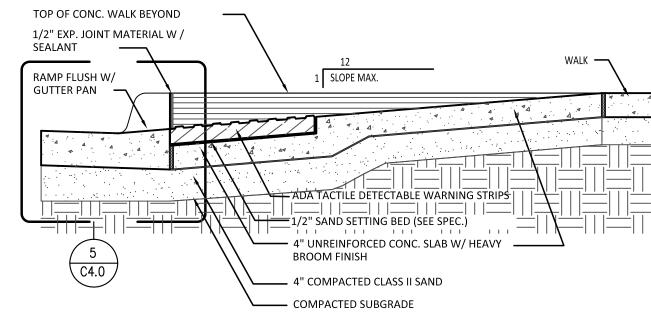
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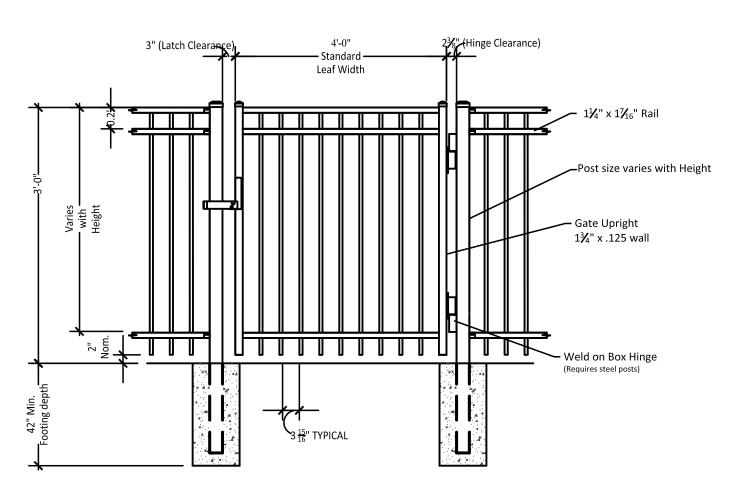
Barrier Free Ramp (Type I) Detail



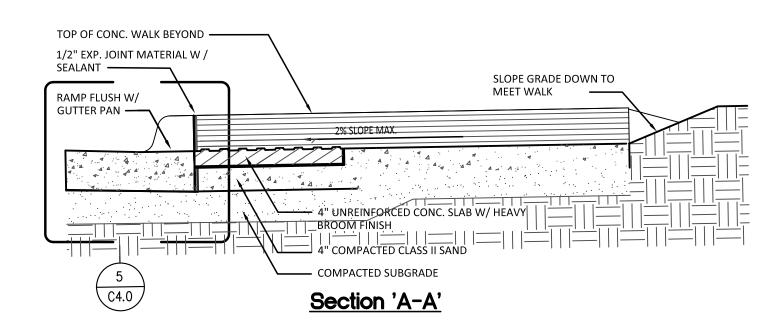


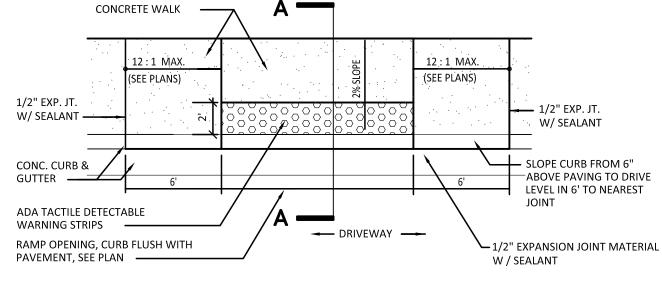Section 'A-A'


7 Barrier Free Ramp (Type II) Detail Not to Scale

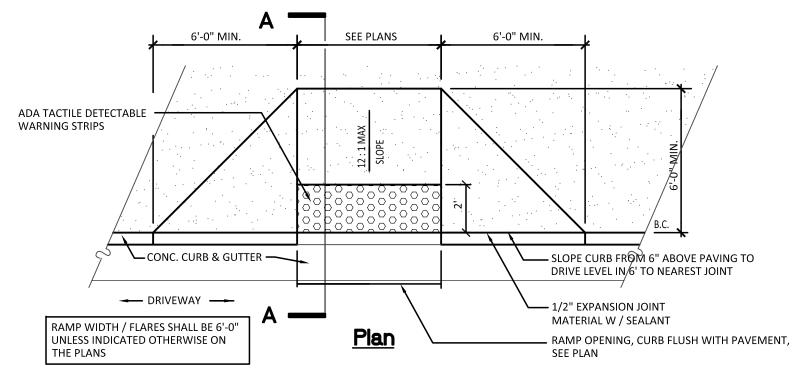

8 4' Width Ornamental Single Gate Detail
Not To Scale

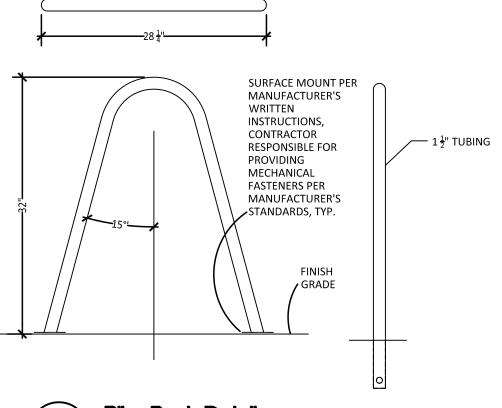


9 Bike Rack Detail Not to Scale

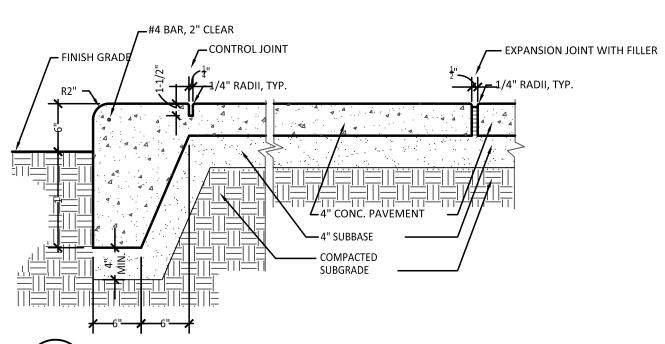


INSTALL NEW CORNER POST FLUSH WITH BUILDING WALL AND CONNECT POST SECURELY TO BUILDING

Section-Integral Walk + Curb 4' Subbase Not To Scale

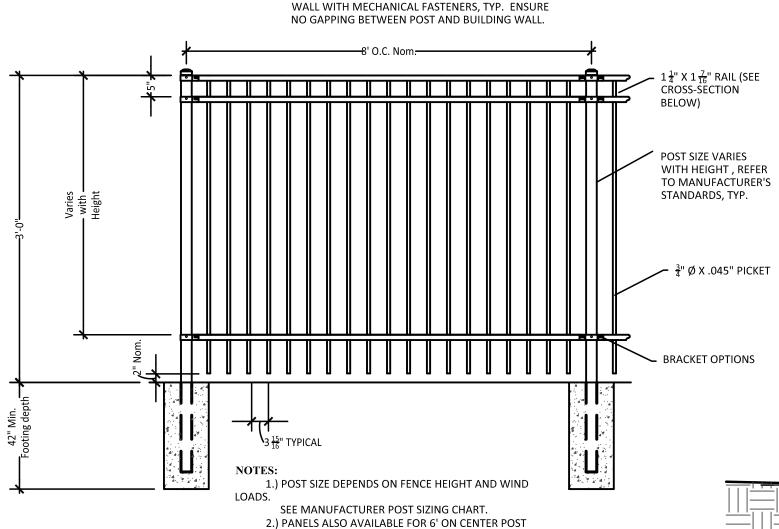


11 36' Height Ornamental Fencing Detail Not To Scale

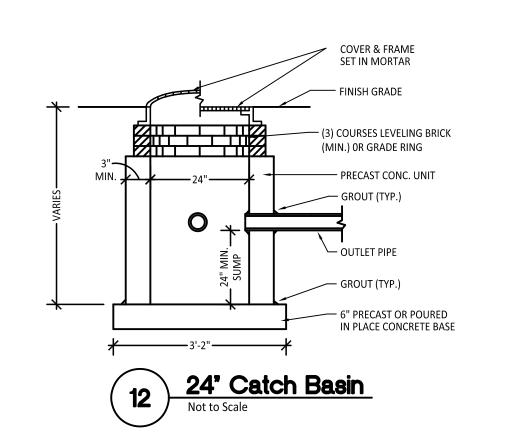


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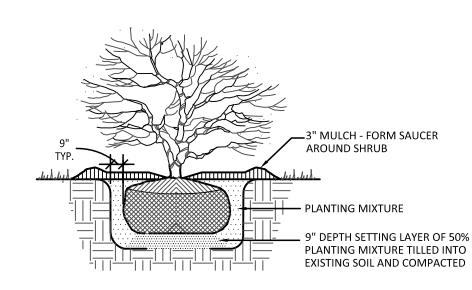
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Section-Conc. Valley Gutter NOT TO SCALE

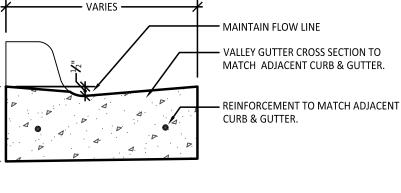

Tree Planting Detail Not To Scale

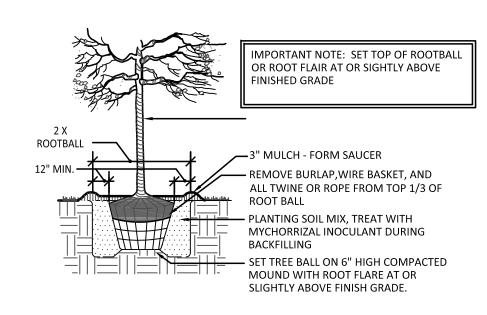


15 Shrub Planting Detail Not To Scale

OVERLAPPED ON TOP, TYP.

REFER TO SOILS REPORT FOR STORM STRUCTURE FINGER DRAIN INFORMATION, TYP.

REFER TO GEOTECHNICAL REPORT AND C301 FOR FINGER DRAIN INFORMATION, FINGER DRAINS TO BE INSTALLED JUST BELOW BOTTOM OF ASPHALT PAVING SECTION AND SLOPED TO DRAIN INTO STORMWATER STRUCTURE, TYP., DRAINS TO BE 6" DIAMETER, PERFORATED, CORUGATED PLASTIC DRAIN PIPE, BEDDED AND BACKFILLED WITH MDOT 34R GRADATIONAL REQUIREMENTS AND WRAPPED ENTIRELY IN NON-WOVEN GEOTEXTILE FABRIC THAT IS

— COVER & FRAME, SET IN MORTAR

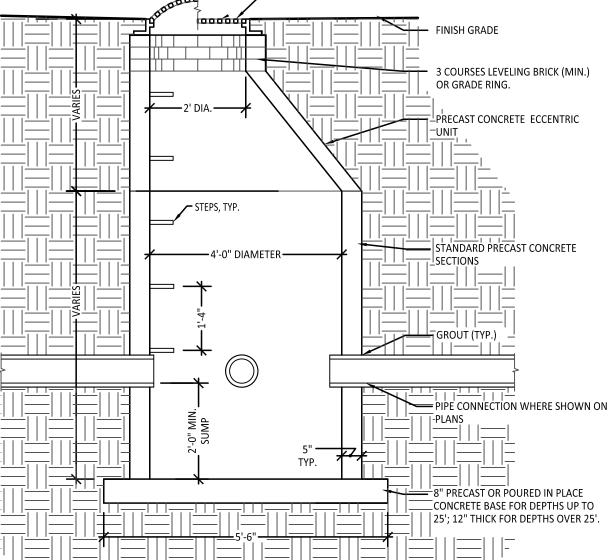

4' Catch Basin Detail

1601 East Main St. Details


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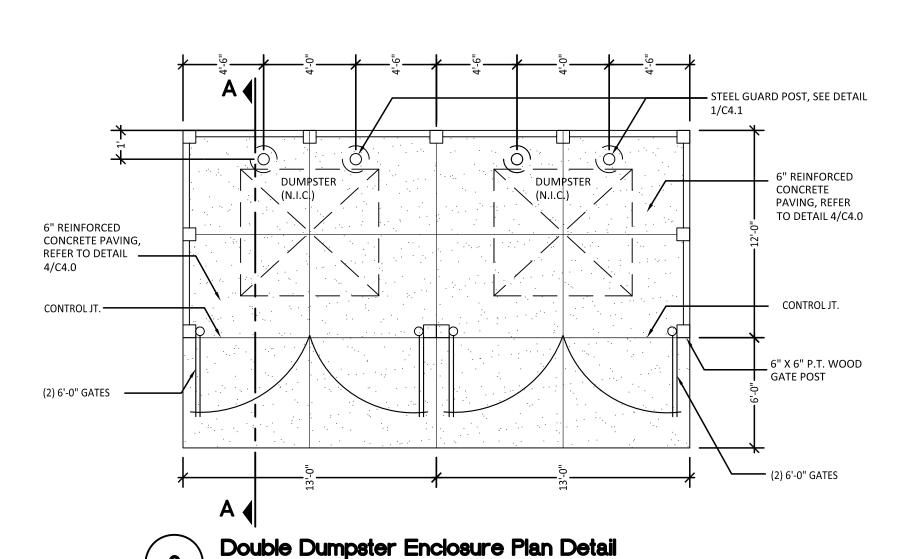
drawing date
QAQC SET
06.10.2022


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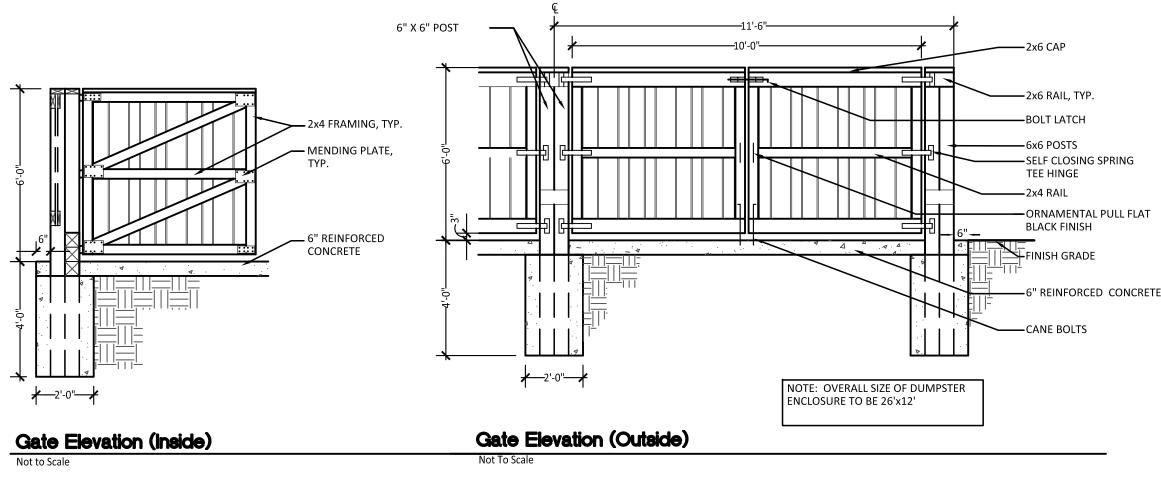
C4.0





Screen Fencing Details



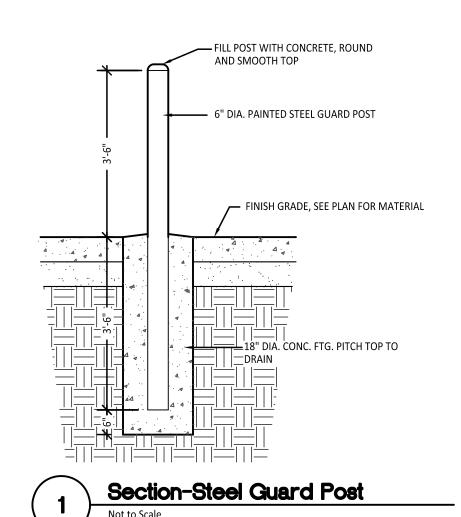

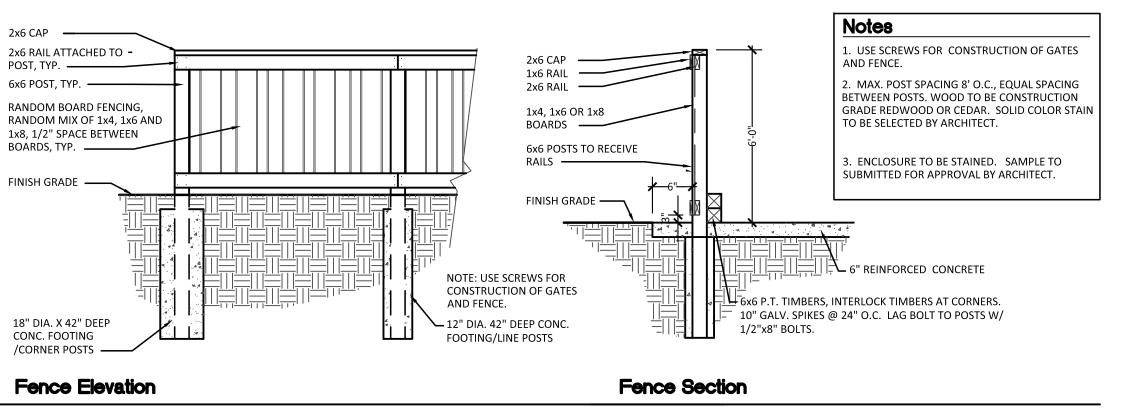

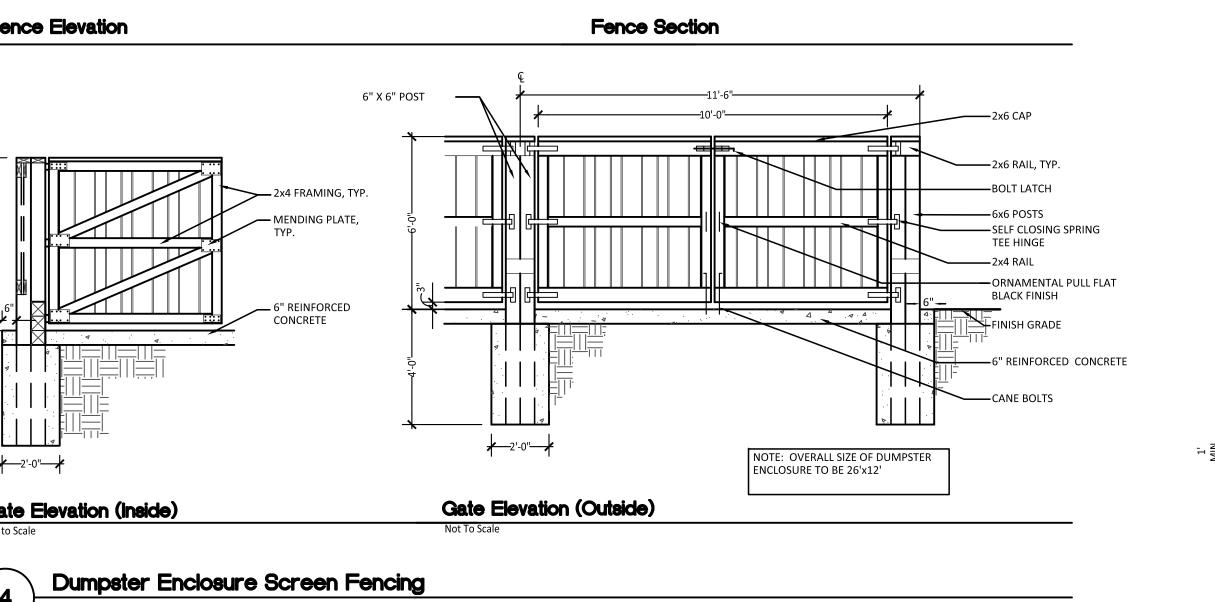

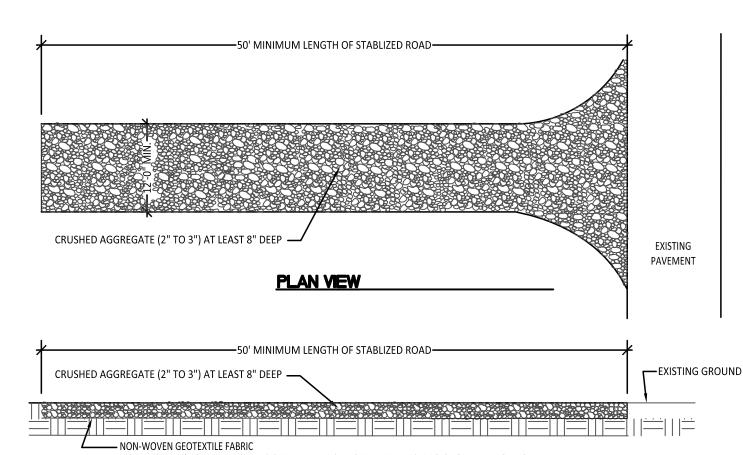

NON-WOVEN GEOTEXTILE FABRIC SHALL BE PLACED OVER THE EXISTING GROUND PRIOR TO PROFILE


NOTES:


PLACING STONE.


1. ESTABLISH STABILIZED CONSTRUCTION ENTRANCE PRIOR TO THE INITIATION OF SITE CONSTRUCTION ACTIVITIES.

2. CARE SHOULD BE TAKEN TO PREVENT MATERIAL MOVEMENT INTO ADJACENT WETLANDS/WATERBODIES. 3. CARE SHOULD BE TAKEN TO MAINTAIN EXISTING ROADSIDE DRAINAGE VIA CULVERT INSTALLATION, WITH SEDIMENT SUMP PLACED DOWNFLOW OF CULVERT.


Double Dumpster Enclosure Plan Detail

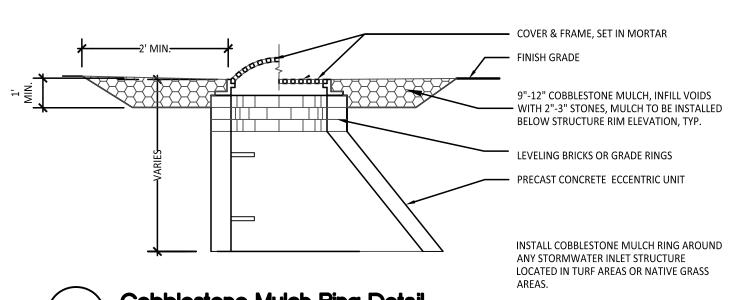

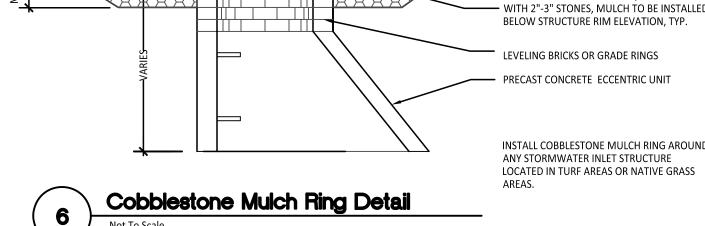


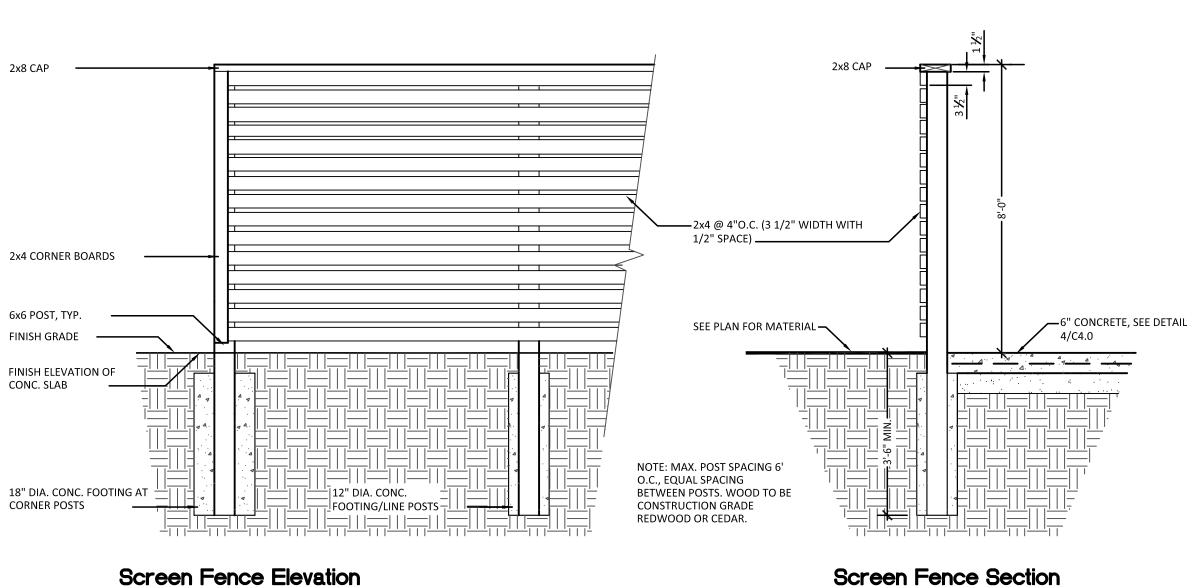

Screen Fence Section

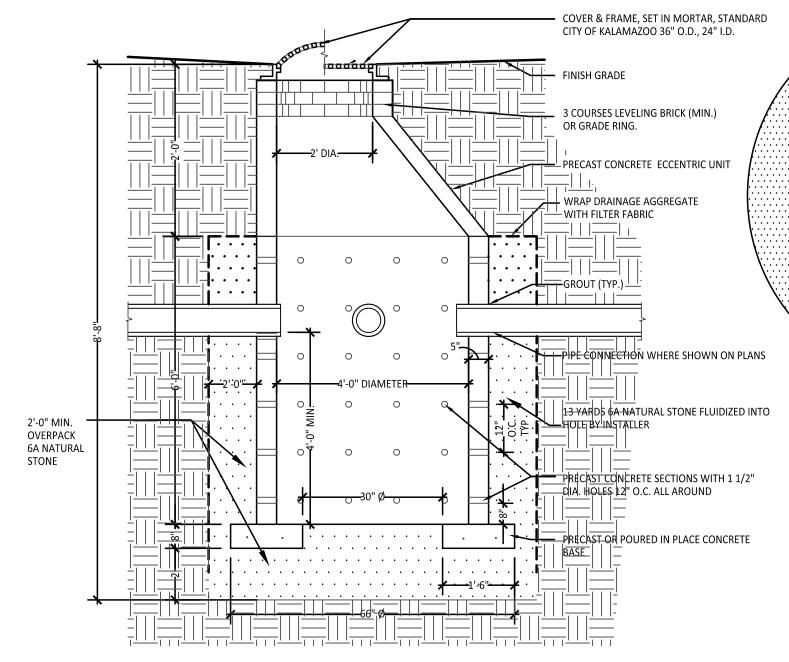

48" Dia. Precast Concrete Leaching Basin Detail

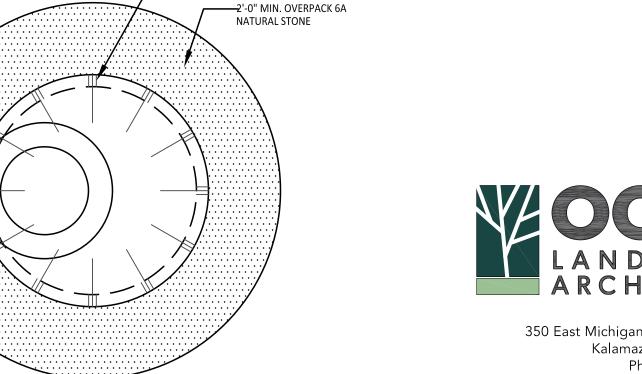

—(12) $1\frac{1}{2}$ " Ø OPENINGS,

NOTE: SET LEACHING BASIN FIRST ON 2'-0" DEPTH STONE BED THEN HAVE STONE INSTALLER TRUCK LOAD FLUIDIZED 6A NATURAL STONE INTO HOLE

LEACHING BASIN INSTALLATION TO MEET CITY OF KALAMAZOO ENGINEERING STANDARDS.


REFER TO SOILS REPORT FOR STORM STRUCTURE FINGER DRAIN INFORMATION, TYP.

REFER TO GEOTECHNICAL REPORT AND C301 FOR FINGER DRAIN INFORMATION, FINGER DRAINS TO BE INSTALLED JUST BELOW BOTTOM OF ASPHALT PAVING SECTION AND SLOPED TO DRAIN INTO STORMWATER STRUCTURE, TYP., DRAINS TO BE 6" DIAMETER, PERFORATED, CORUGATED PLASTIC DRAIN PIPE, BEDDED AND BACKFILLED WITH MDOT 34R GRADATIONAL REQUIREMENTS AND WRAPPED ENTIRELY IN NON-WOVEN GEOTEXTILE FABRIC THAT IS OVERLAPPED ON TOP, TYP.



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Maintenance Strip Detail

La
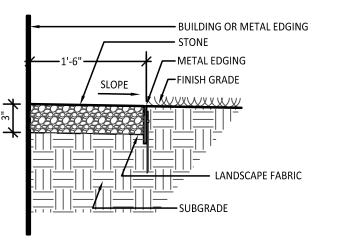
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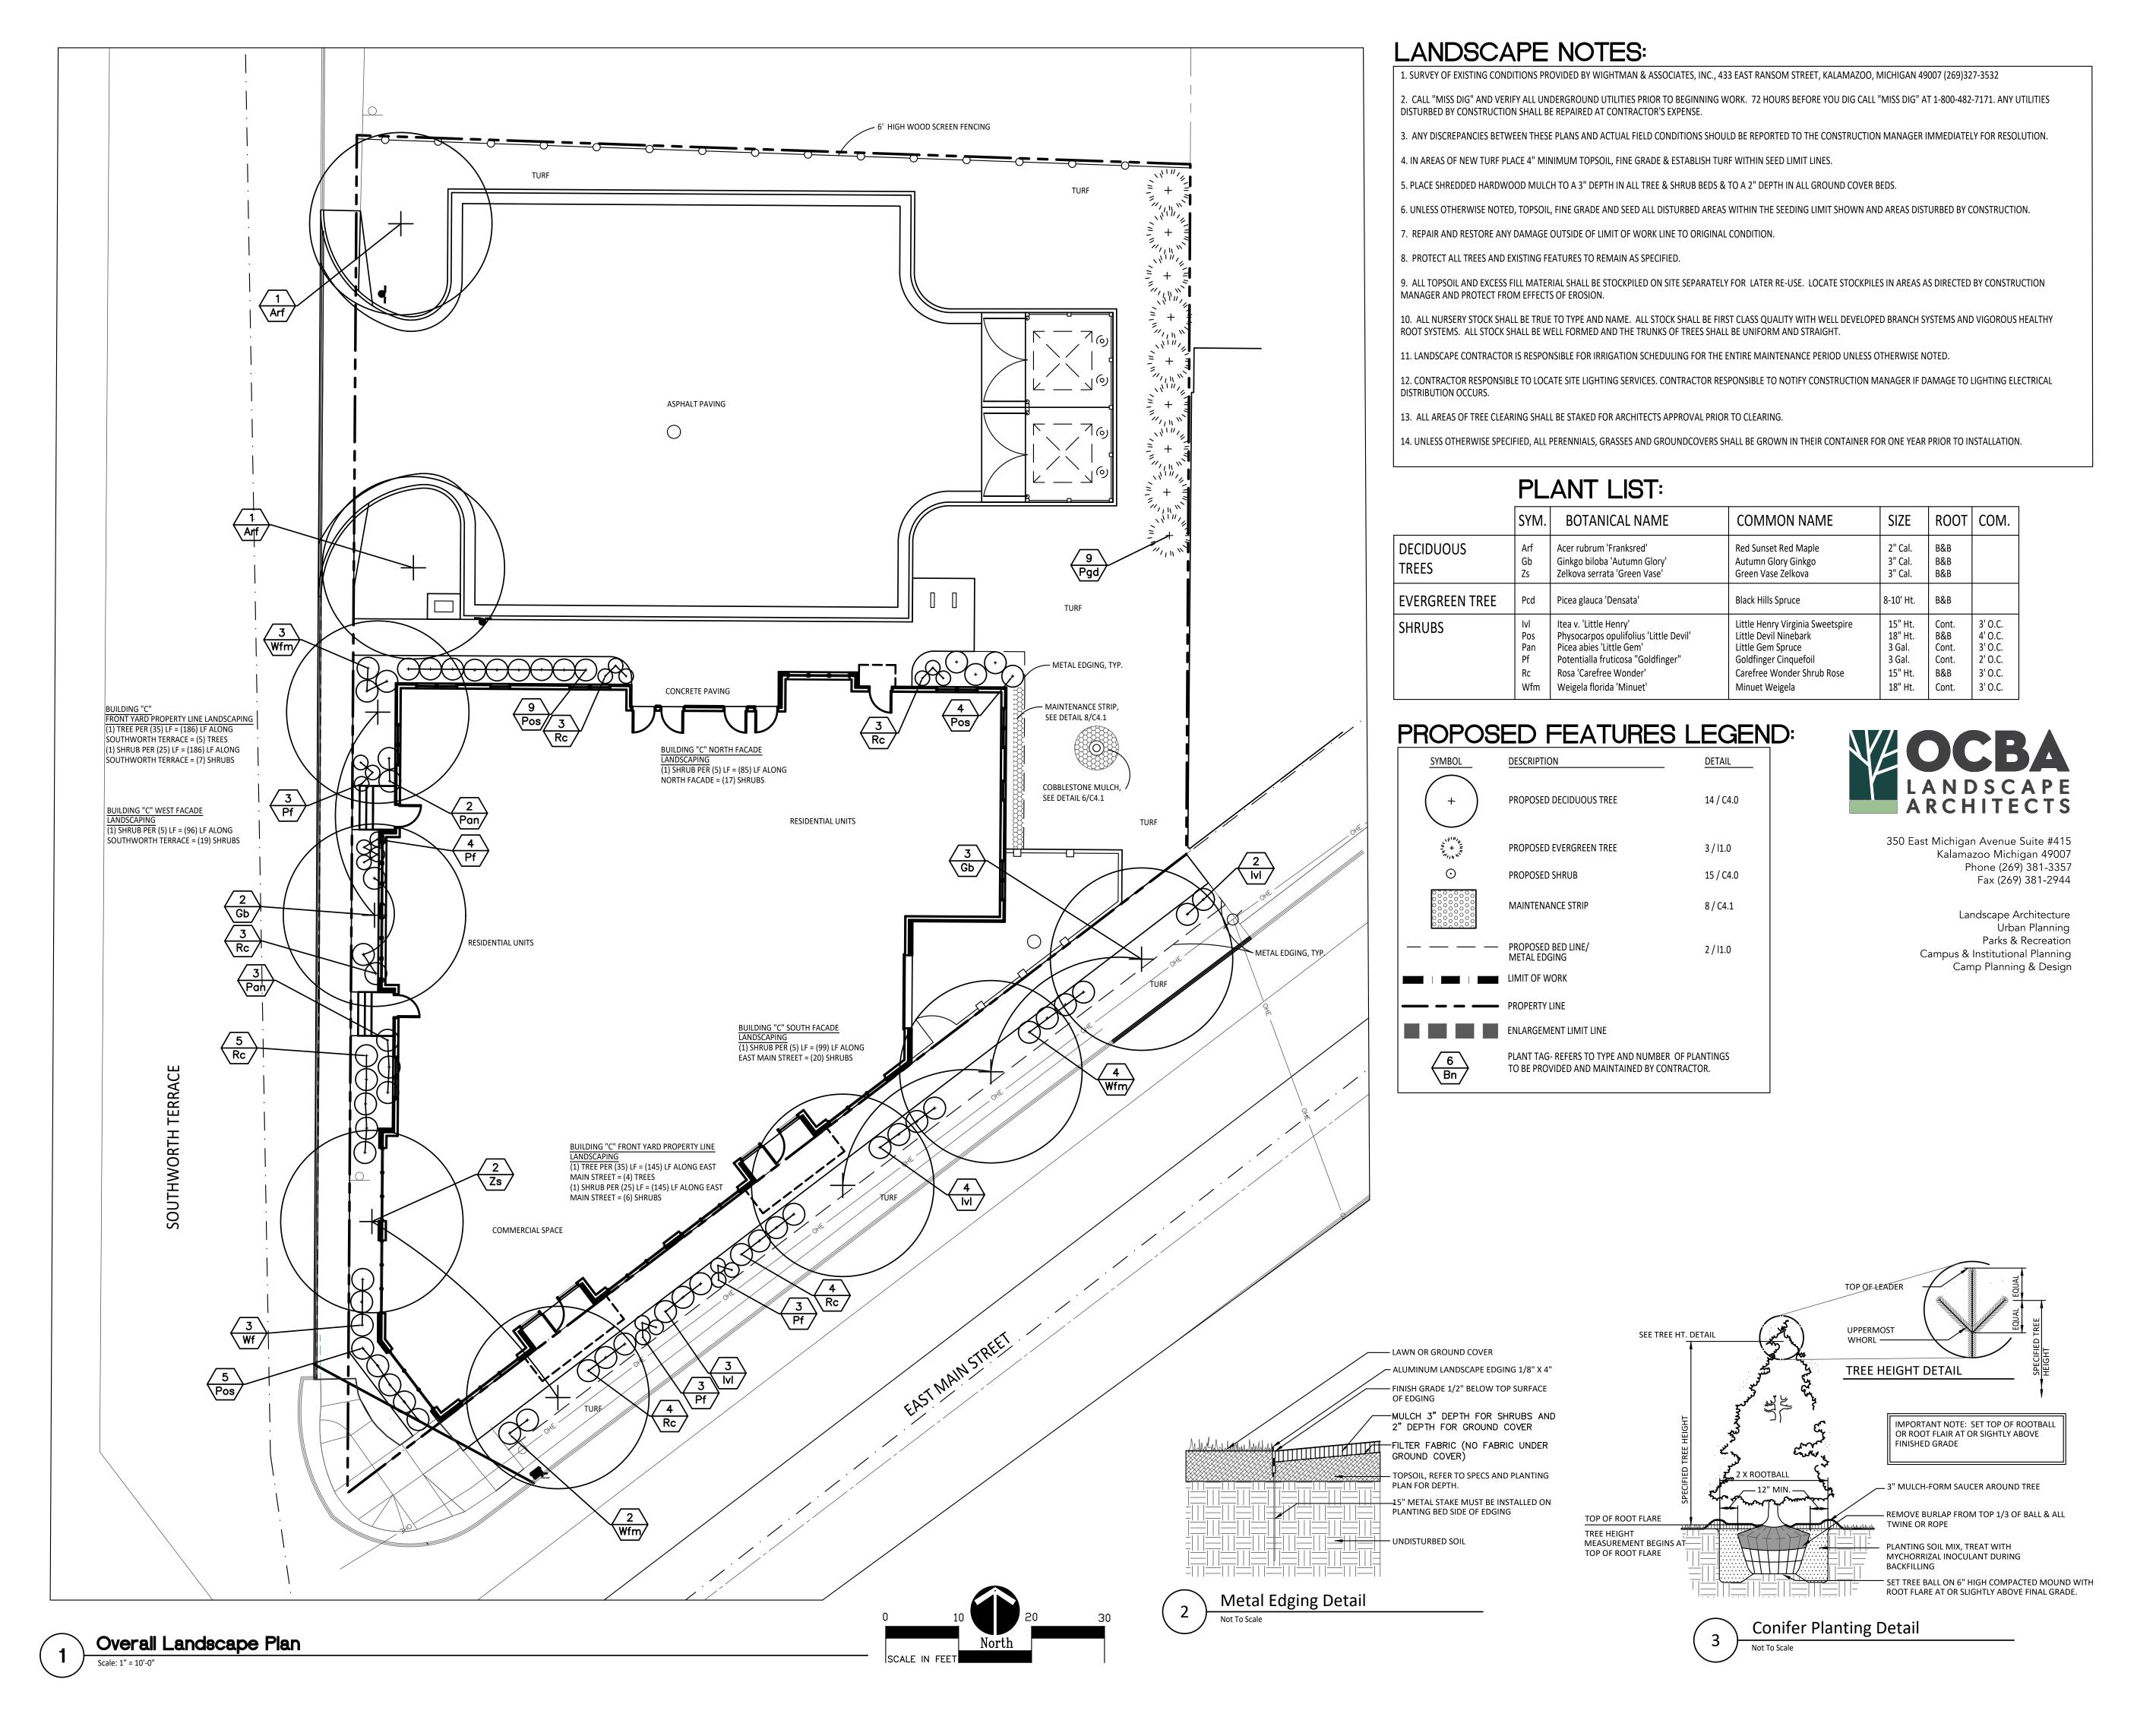
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1601 East Main St. **Details**

> project number 21003

> > drawing date **QAQC SET** 06.10.2022

> > > sheet number



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> **Lare C** MI 49048

Eastside Squa Building C

FINAL SPR SUBMITTAL 06/1

1601 East Main St. Landscape Plan

project number 2 1 0 0 3

drawing date
QAQC SET
06.10.2022

40

sheet number


LIGHTING SYMBOLS


MOUNTING HEIGHTS

WALL MTD. LIGHT FIXTURE

O DOWNLIGHT FIXTURE

EXTERIOR POLE LIGHT

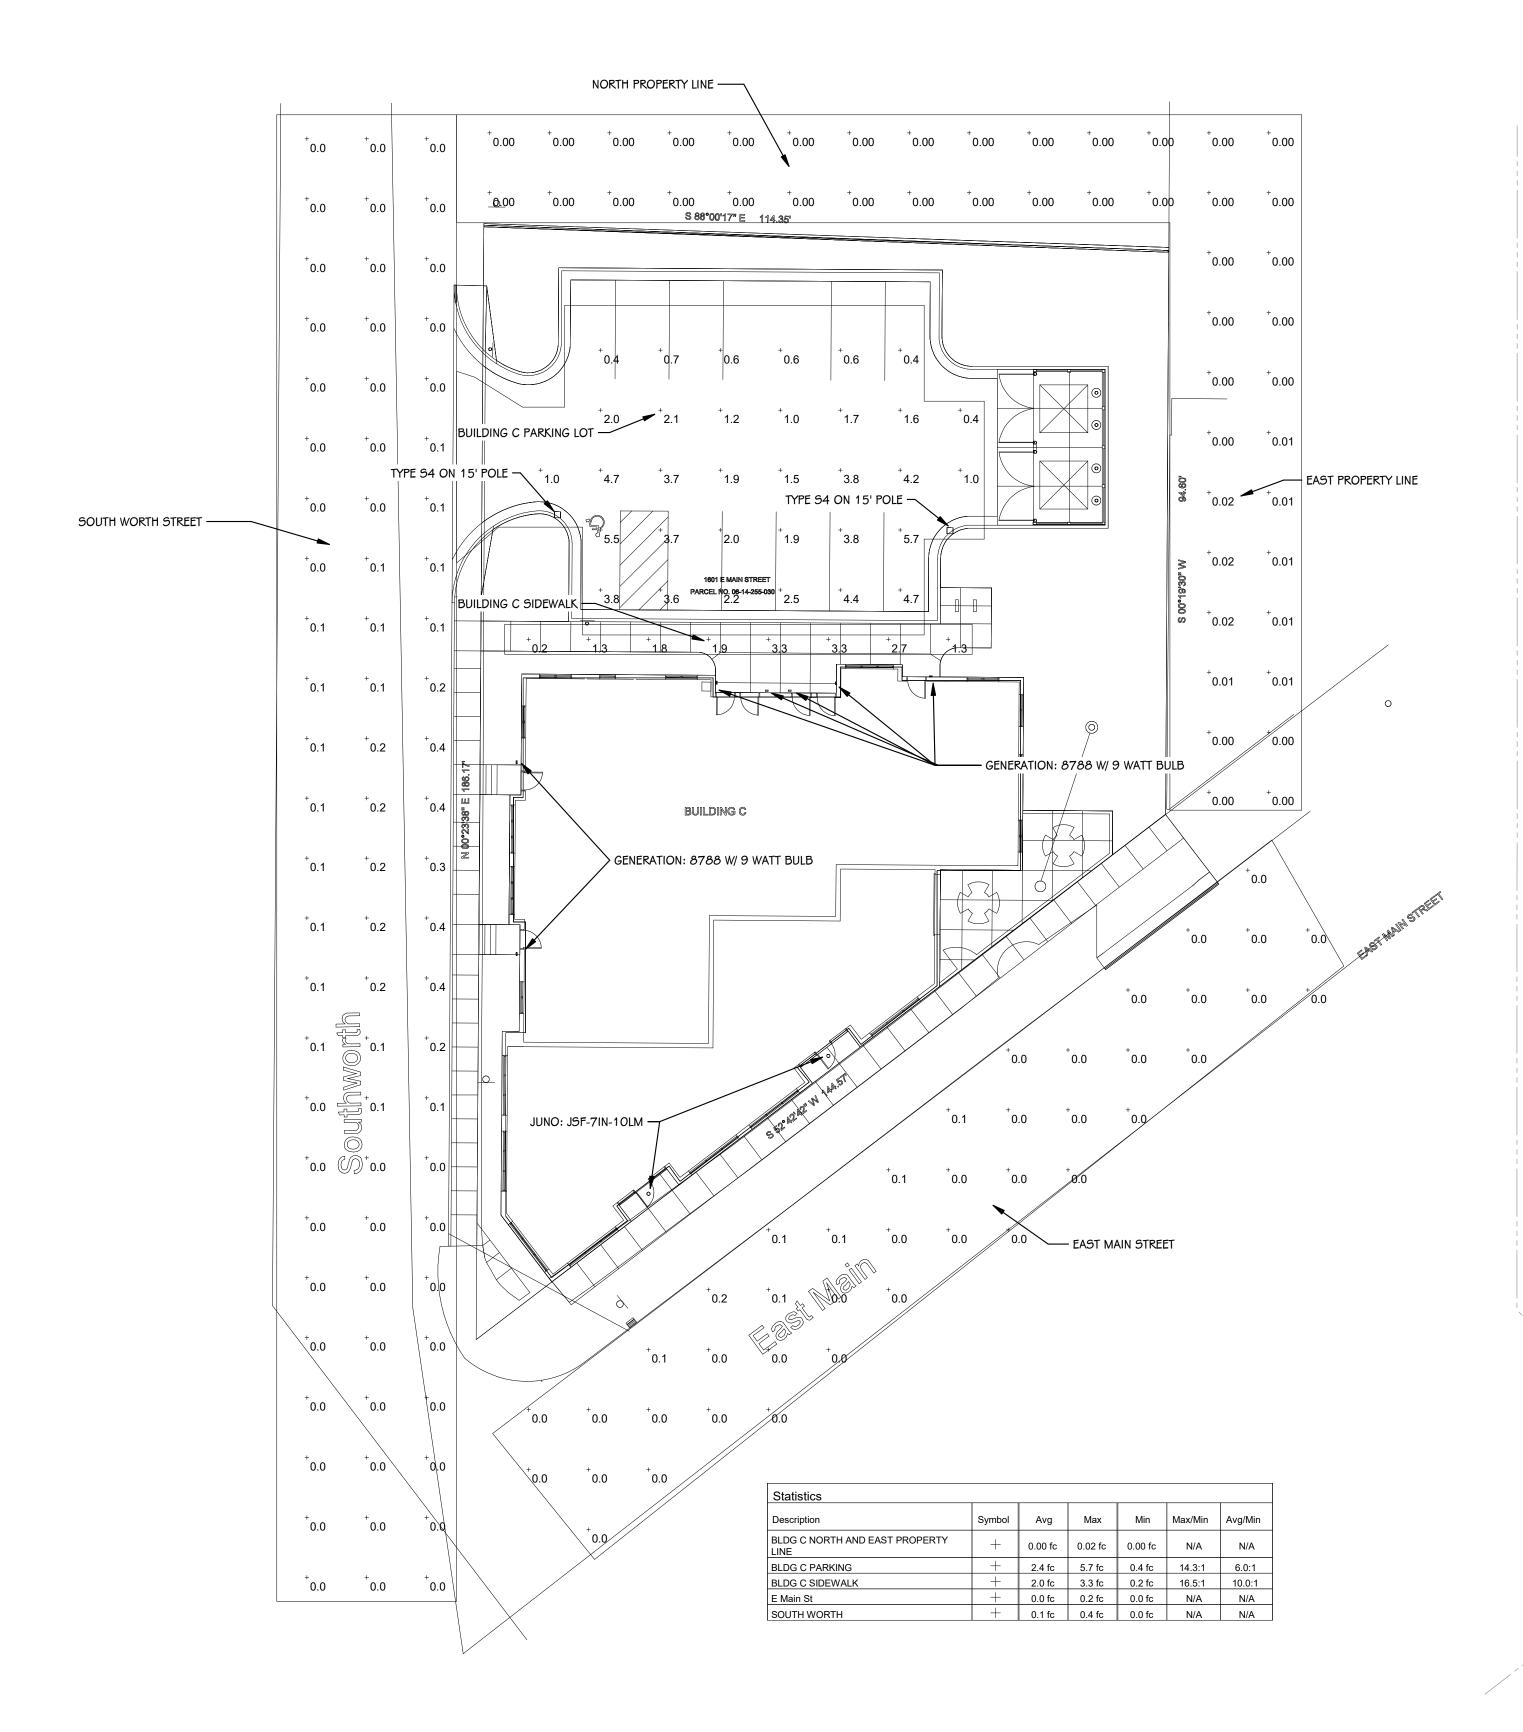

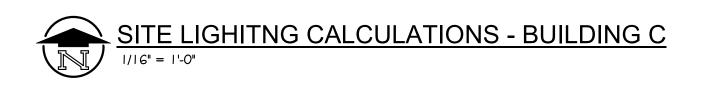



SITE LIGHT FIXTURE SCHEDULE					
ГҮРЕ	PE DESCRIPTION MOUNTING WATTS MANUFACTURER NOTES				NOTES
	LED AREA LIGHT	15' POLE	52 VA	LITHONIA: RSX1 LED P1 40K R45 H5	

BUILDING C

thworth

Sout

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NEW CONSTRUCTION

Eastside Sqaure

Building C

sheet name
ELECTRICAL SITE LIGHITNG
AND CALCULATION PLAN

project number 21198


drawing date


Site Plan Review June 3, 2022


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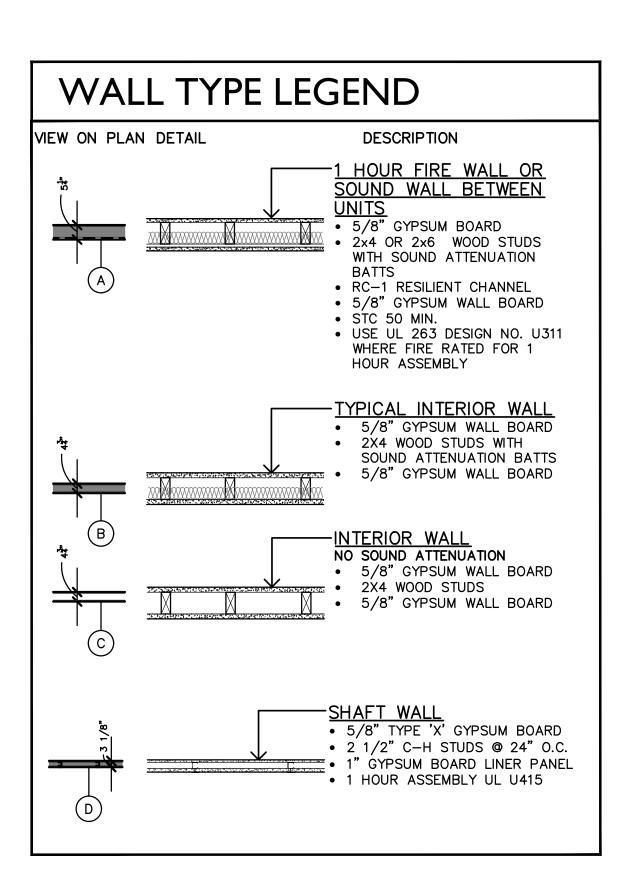
ES I.I


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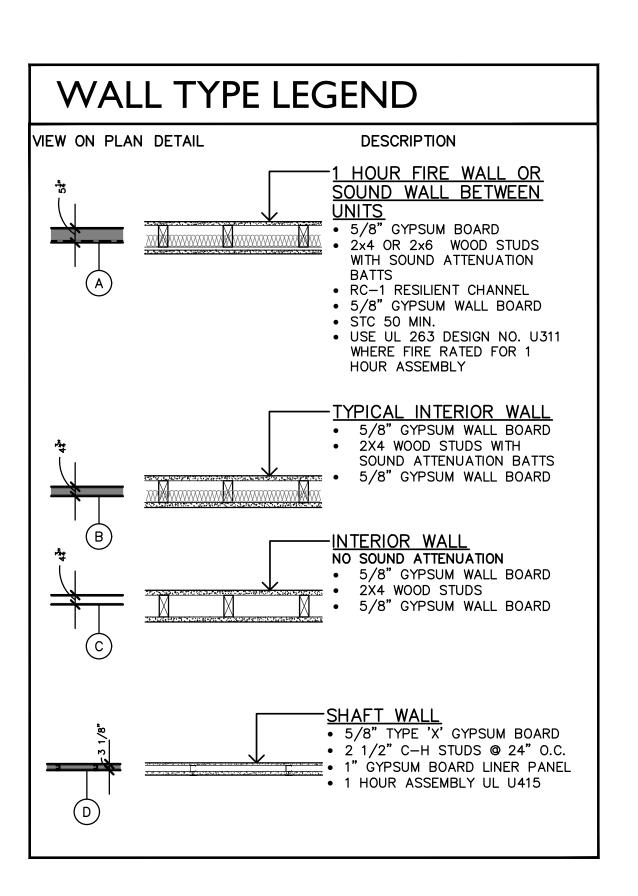


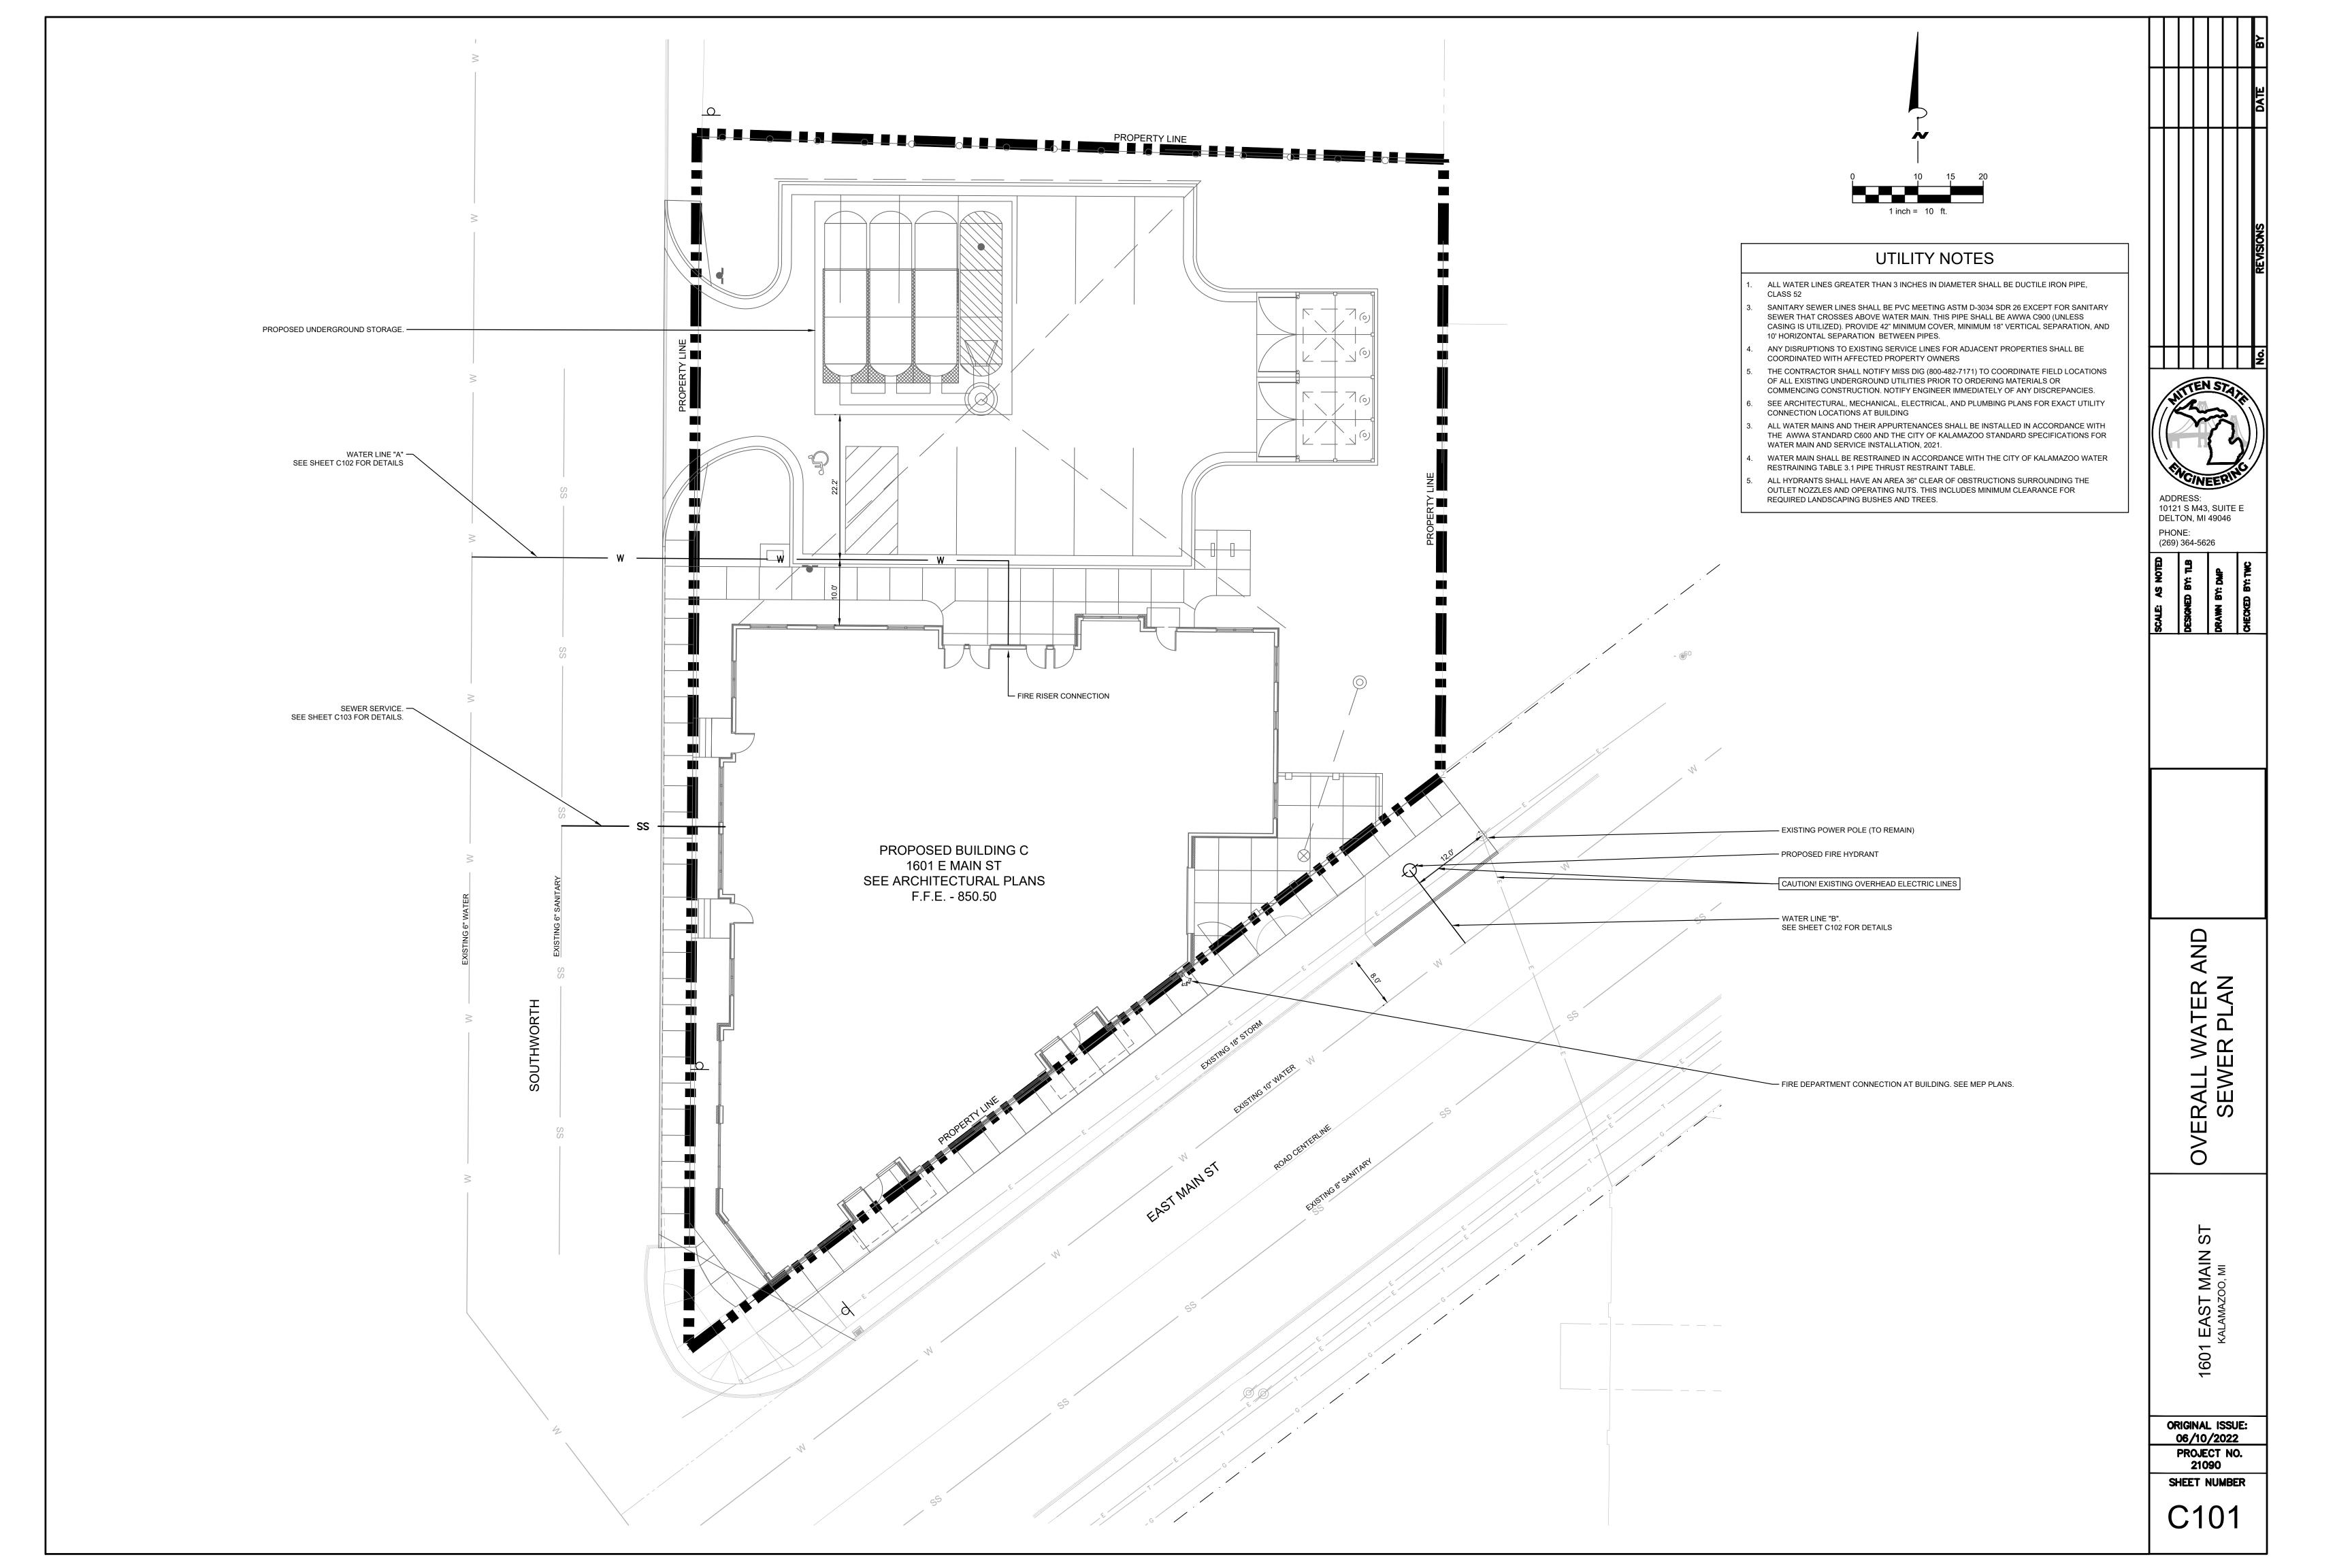


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FIRST FLOOR PLAN -BUILDING C

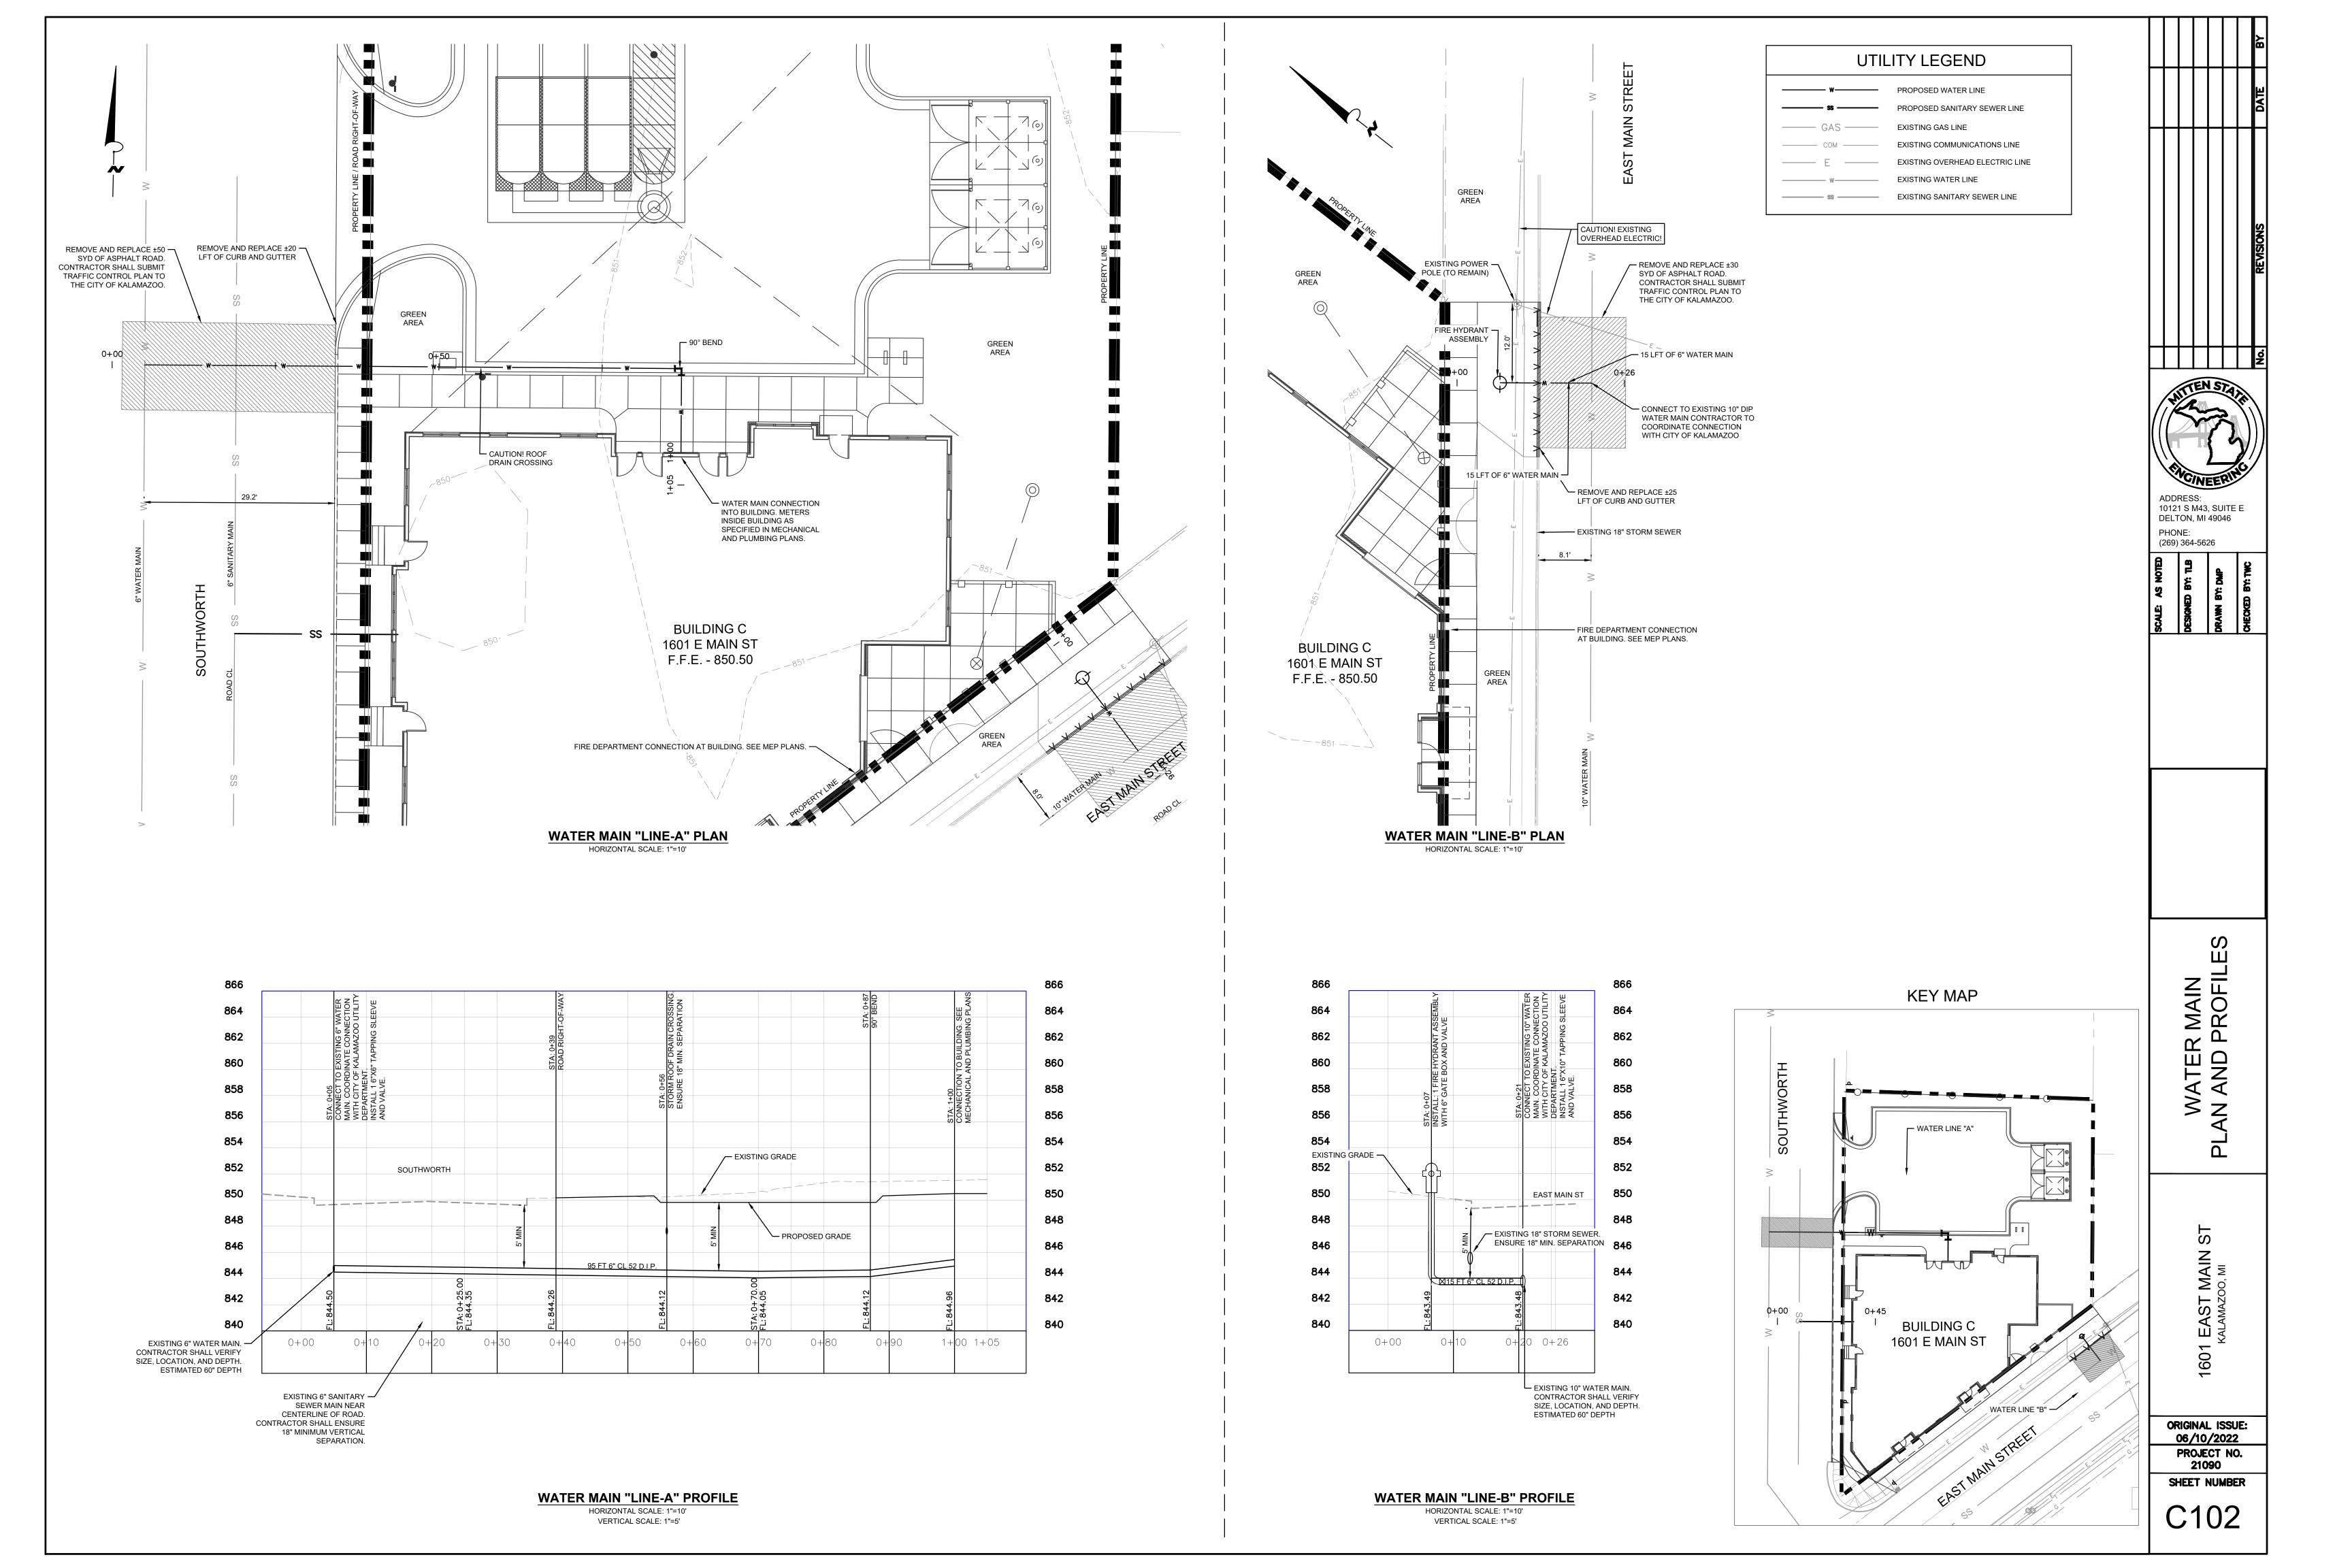drawing date FINAL SPR SUBMITTAL

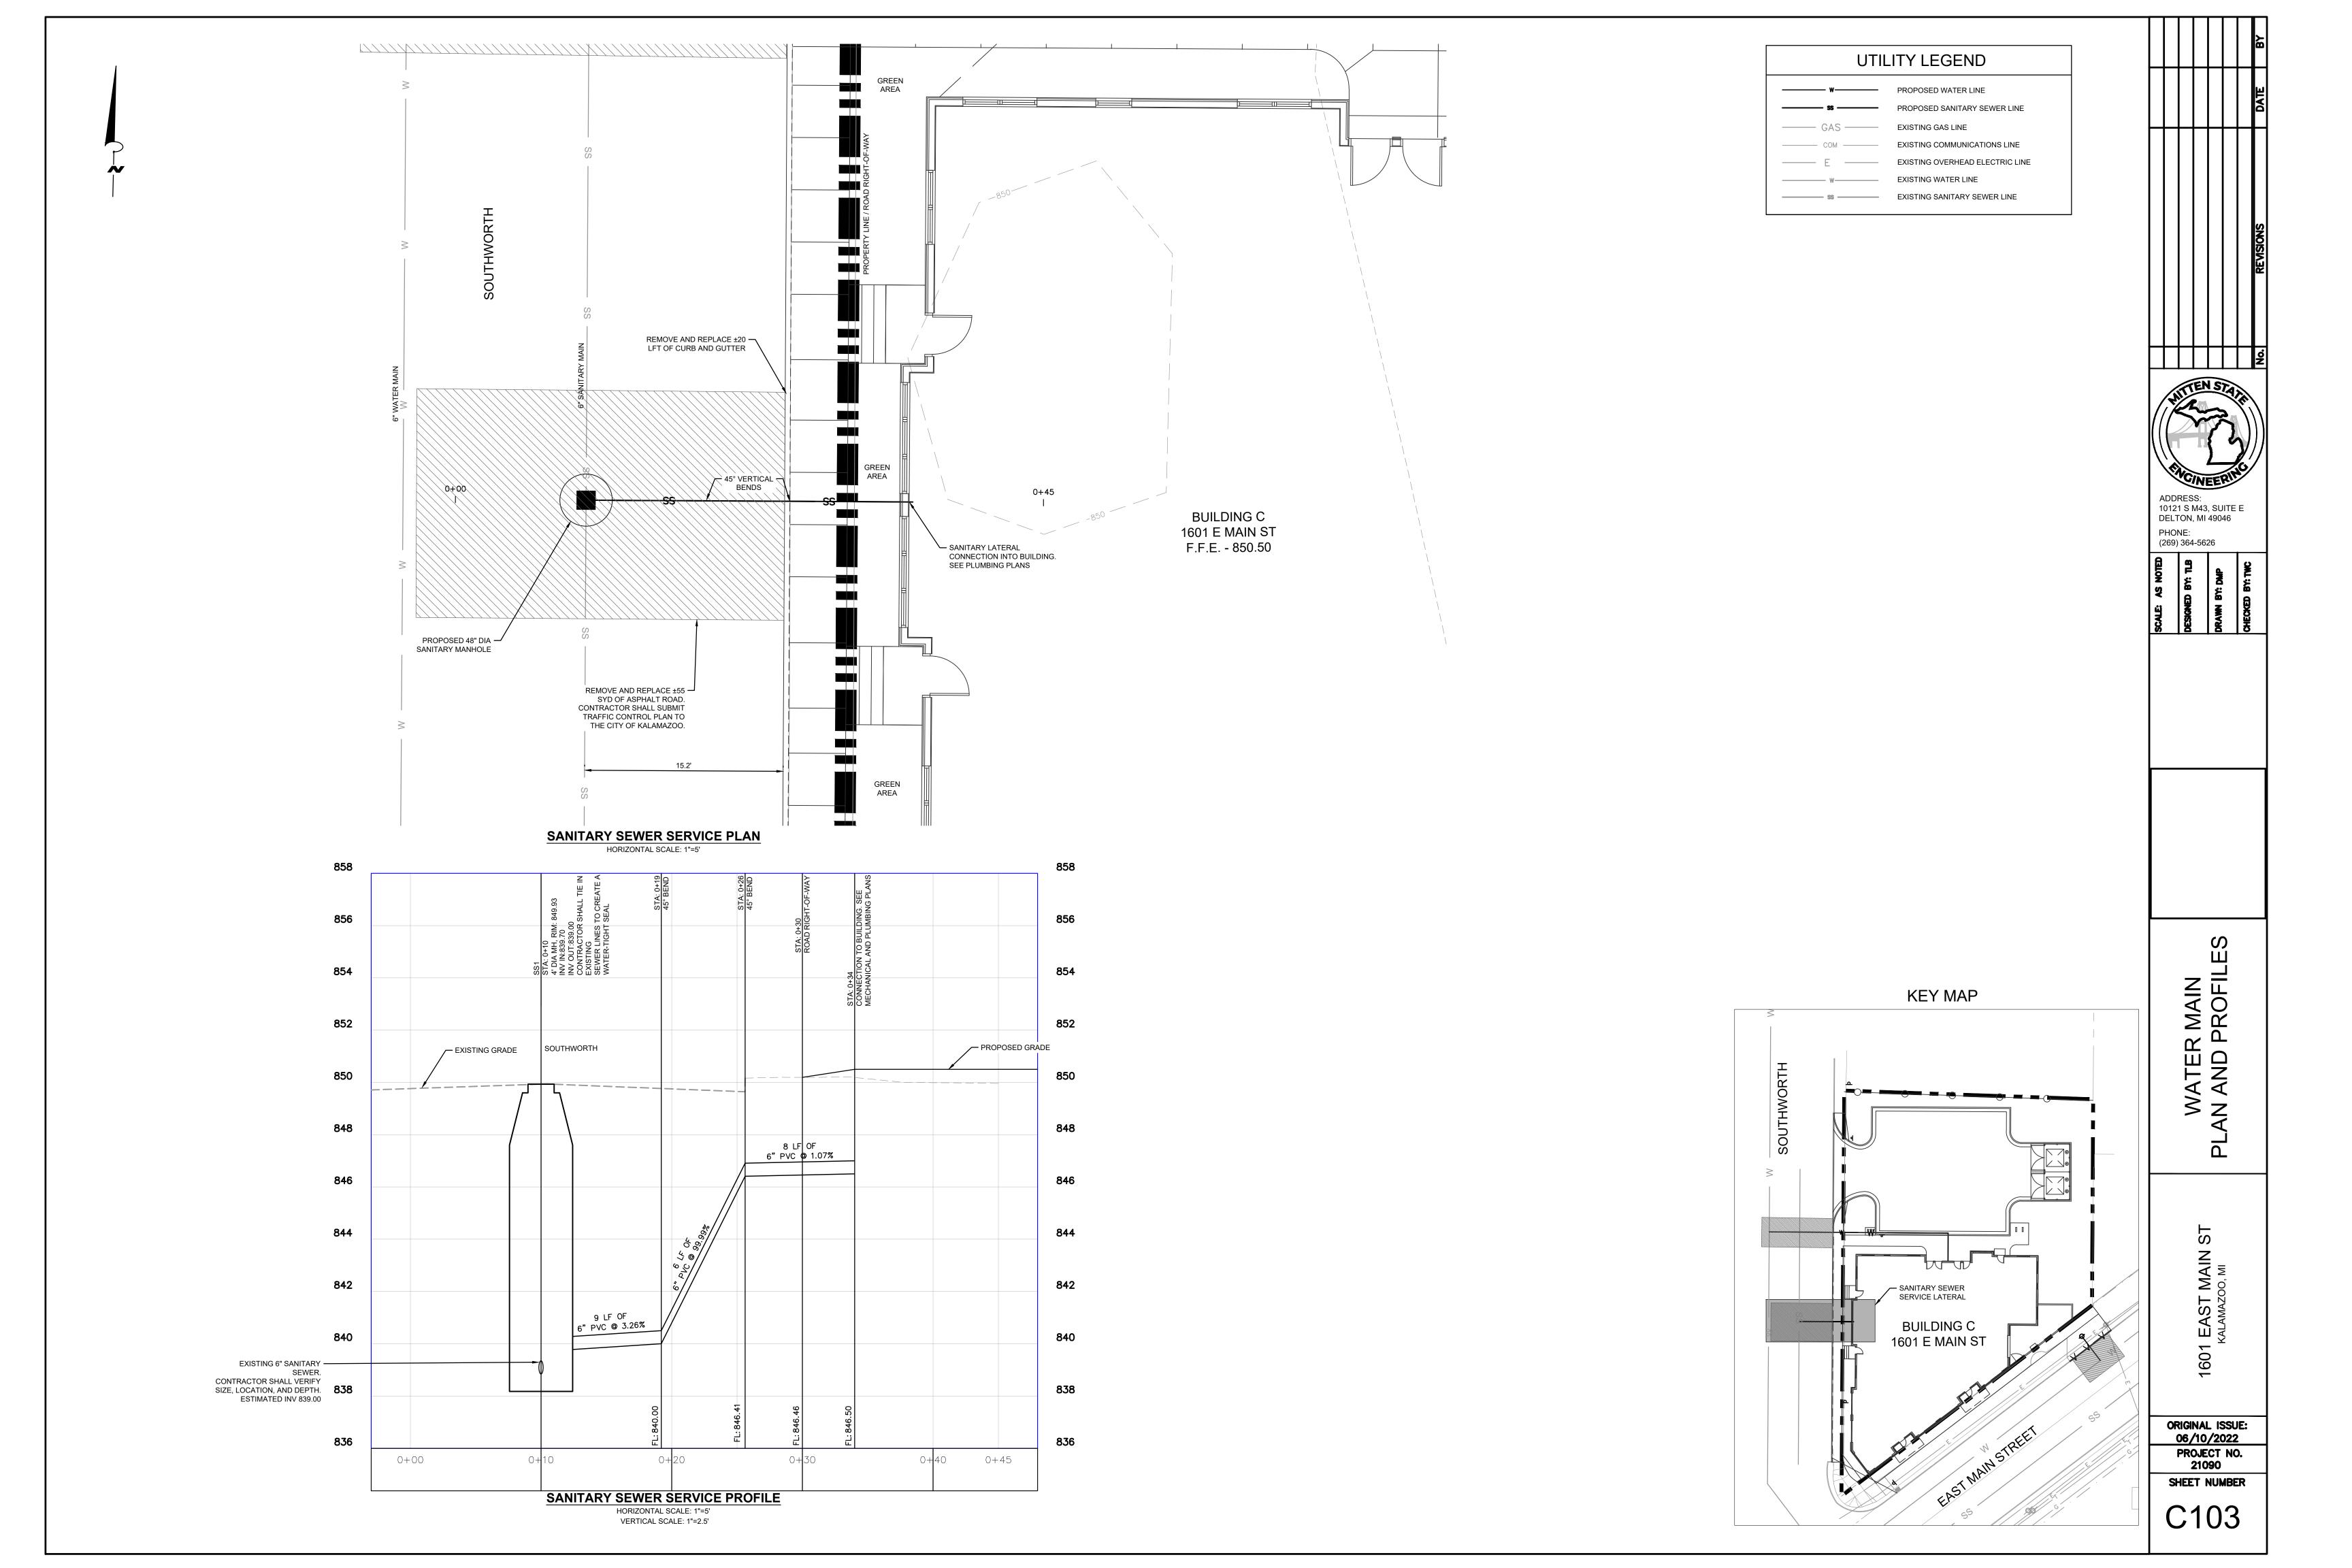

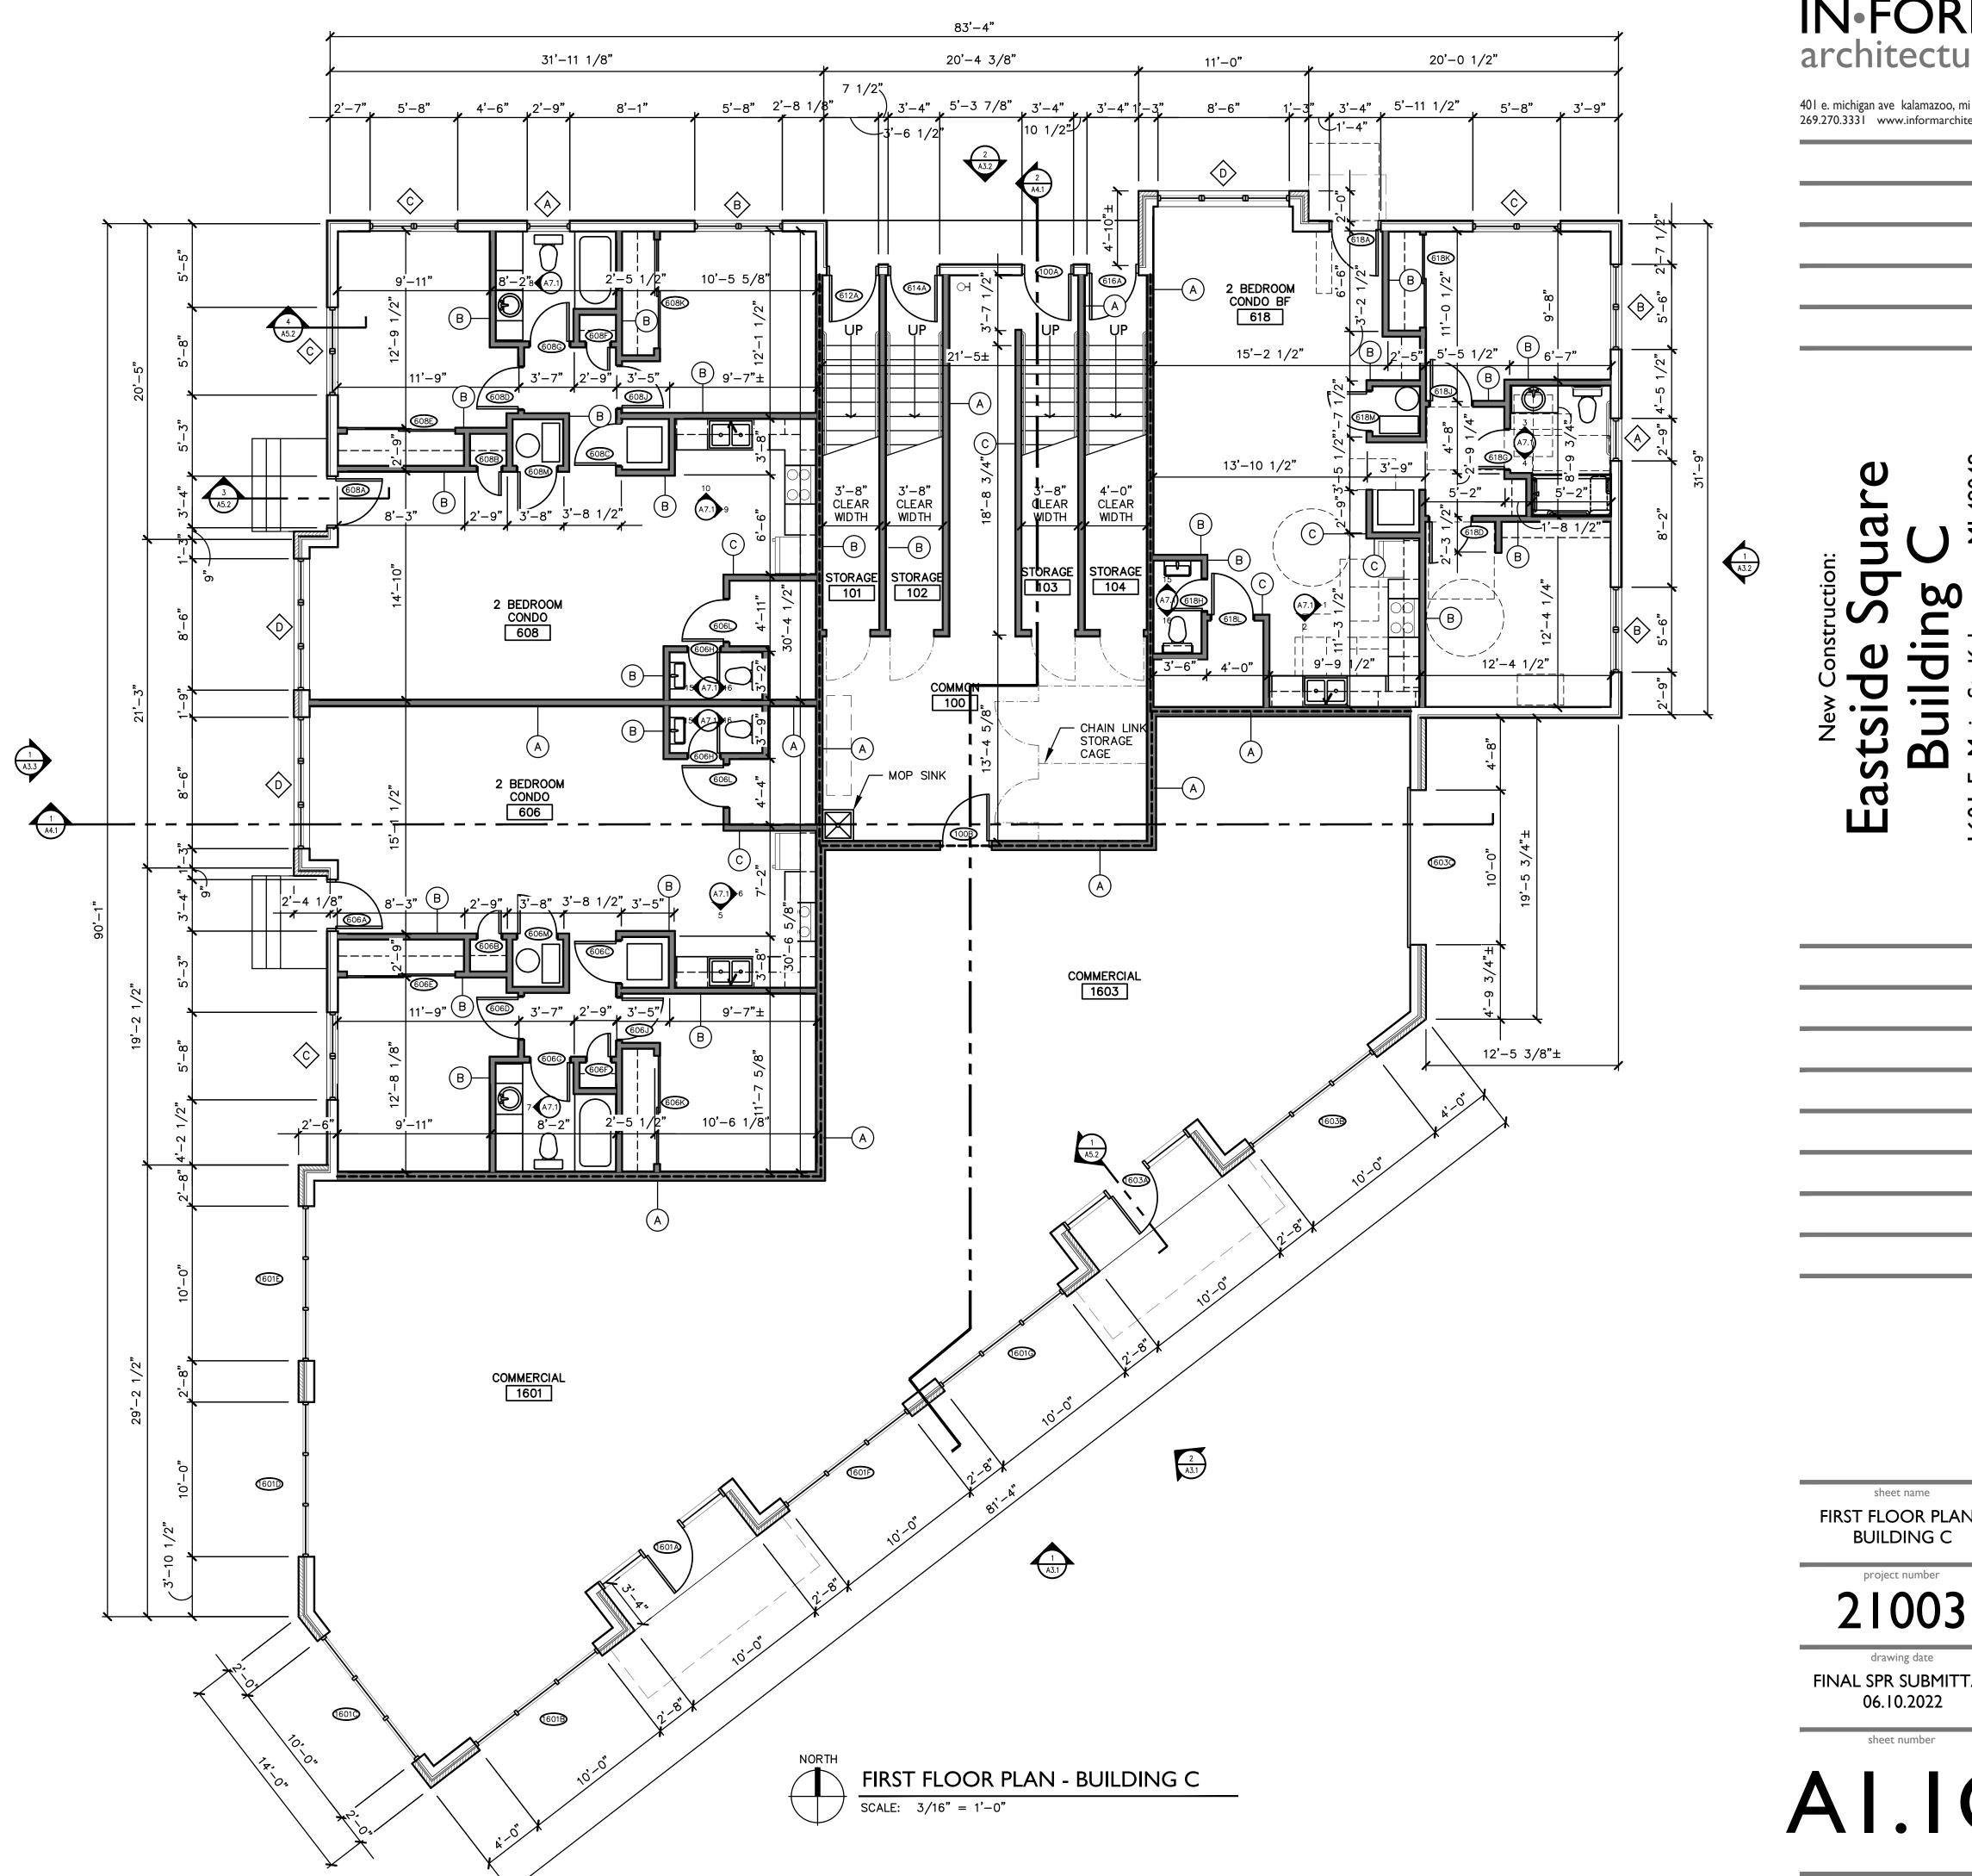

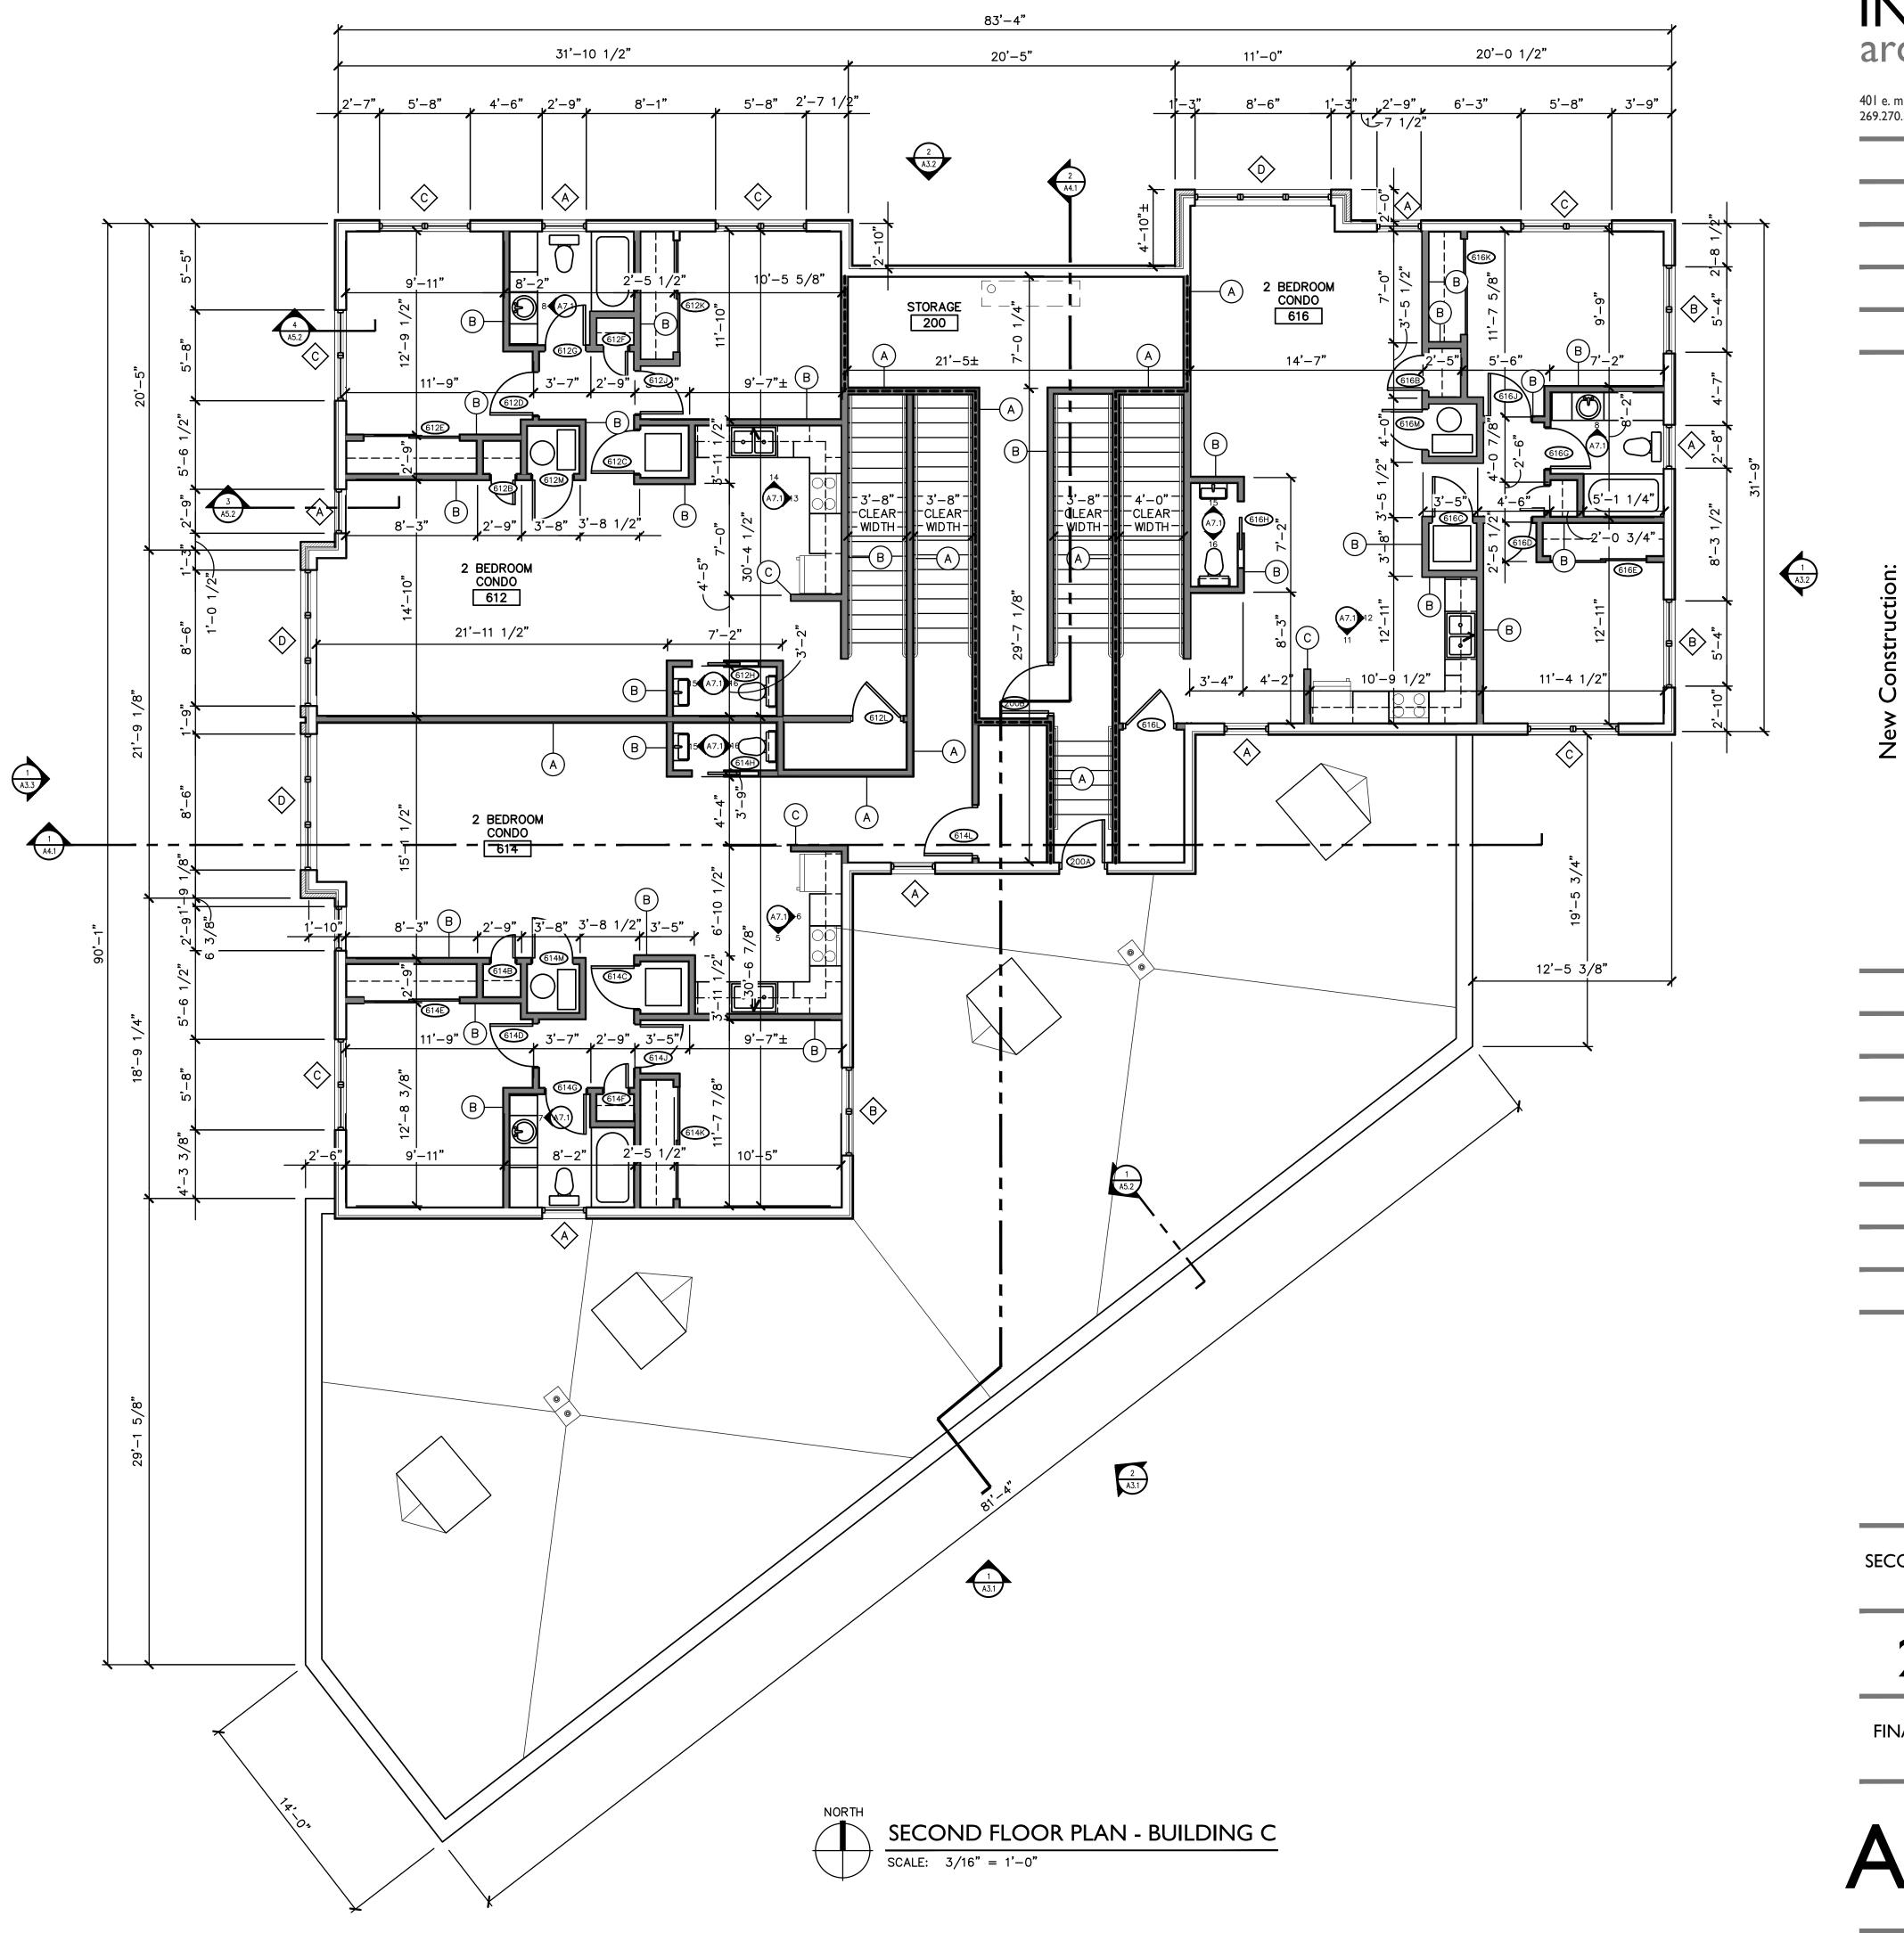
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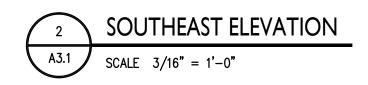
sheet name SECOND FLOOR PLAN -BUILDING C


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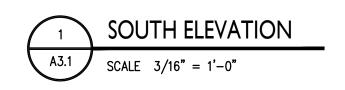
21003

drawing date FINAL SPR SUBMITTAL 06.10.2022





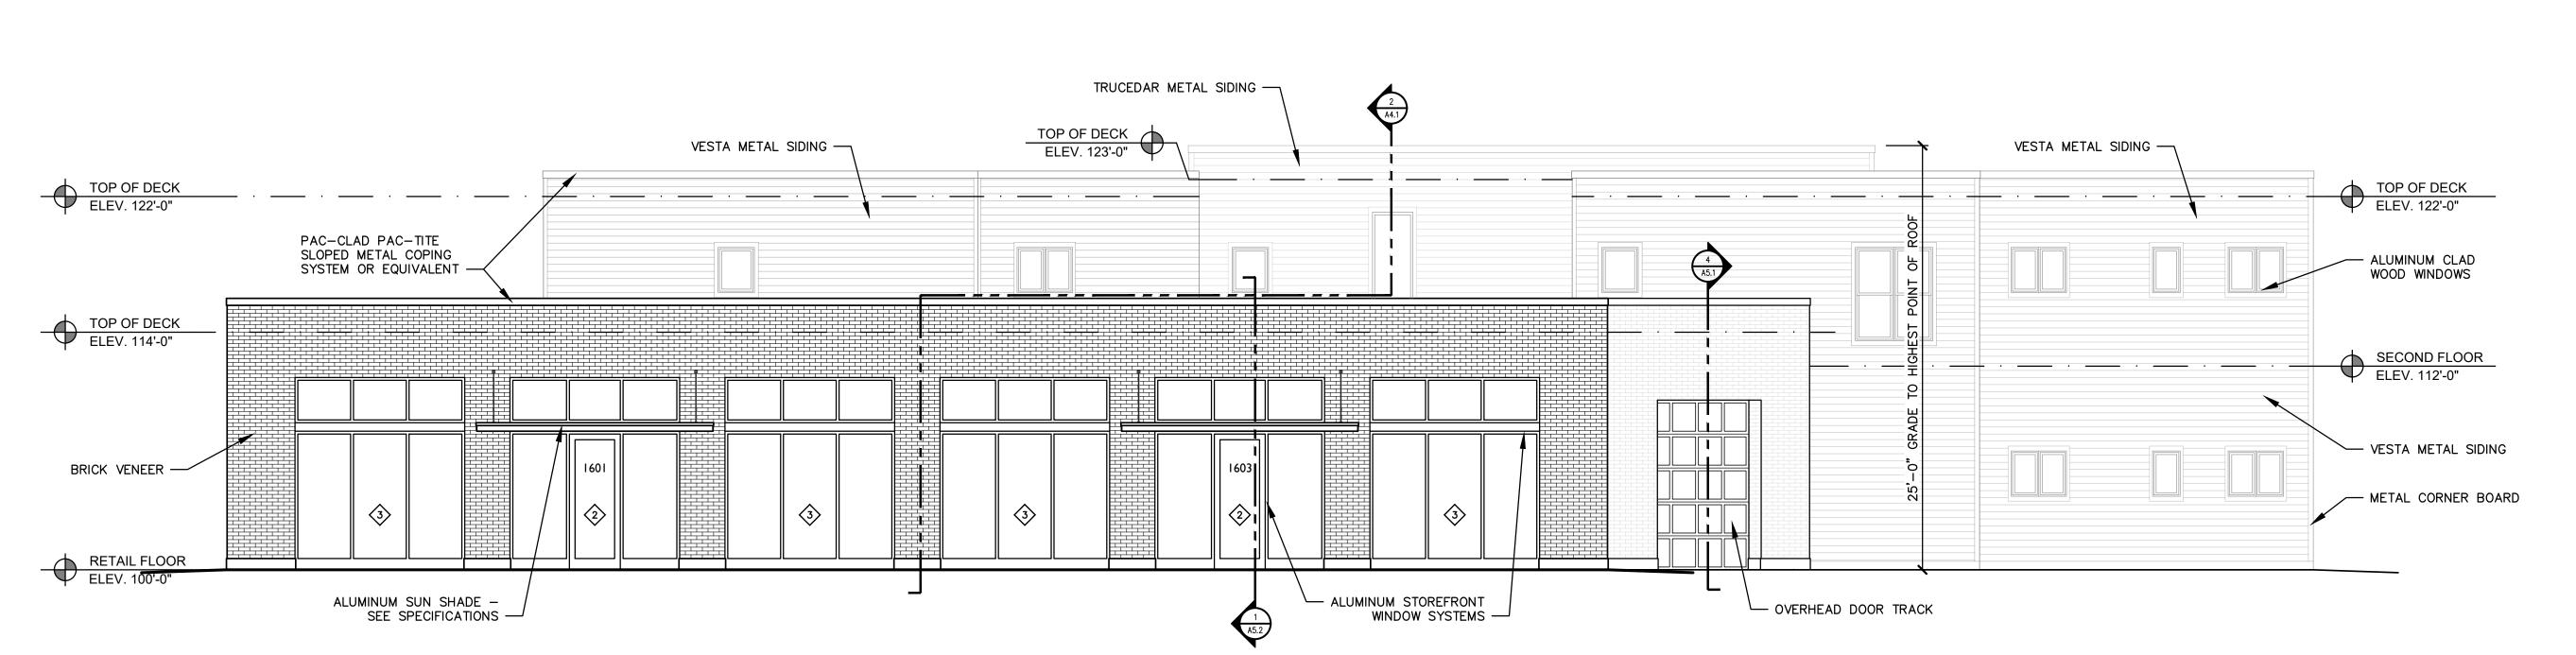

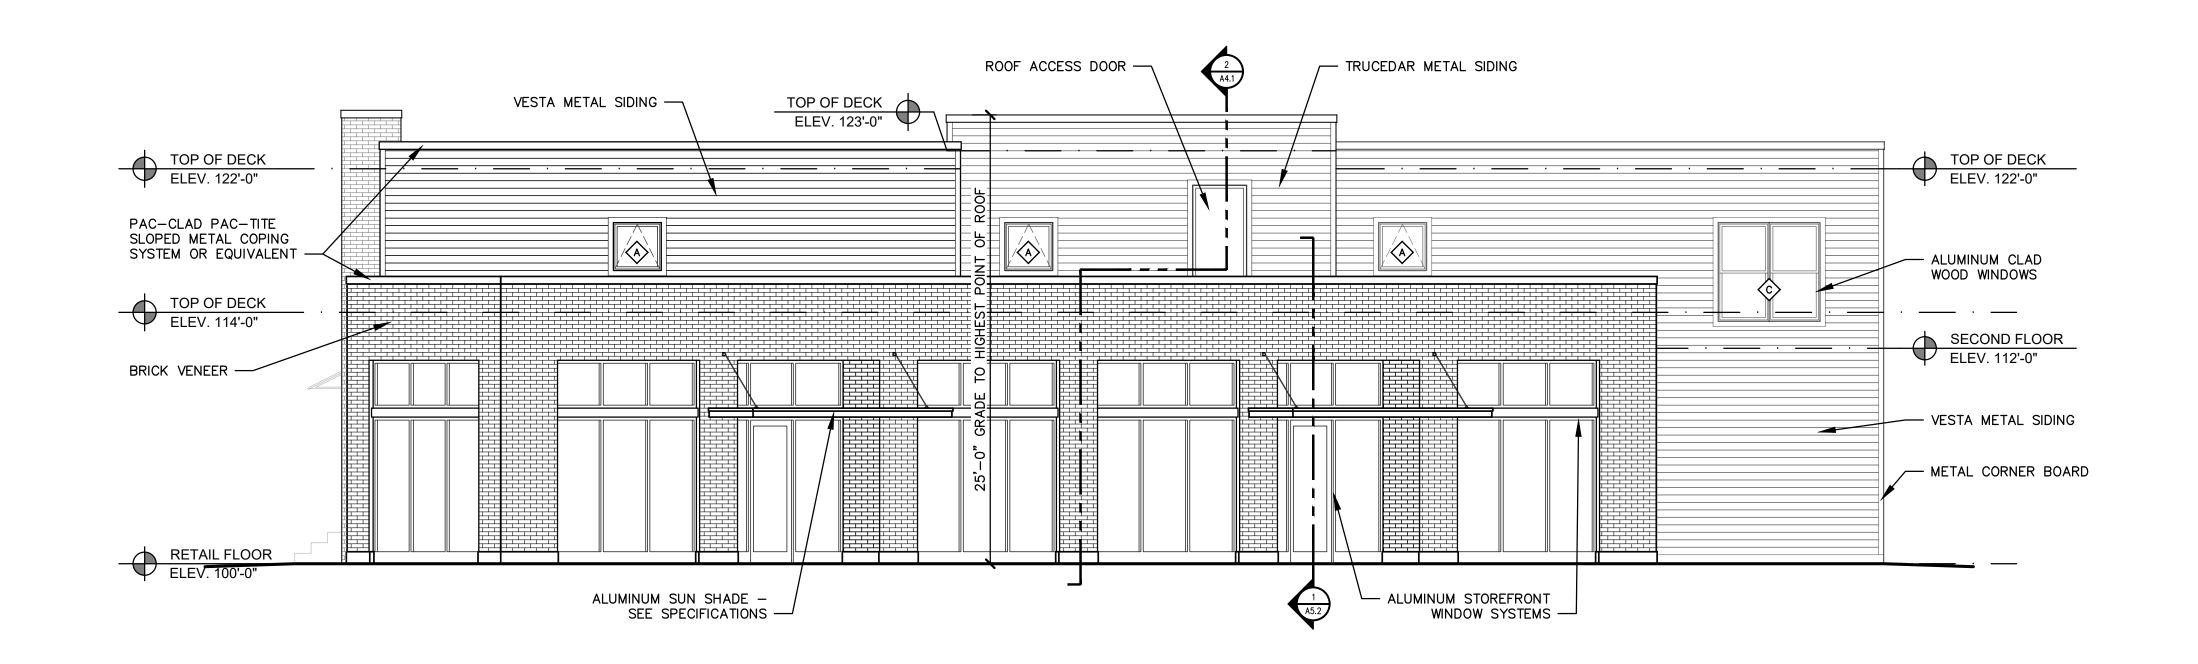

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Square Square Sg C

Eastside Squ Building C

sheet name


EXTERIOR ELEVATIONS


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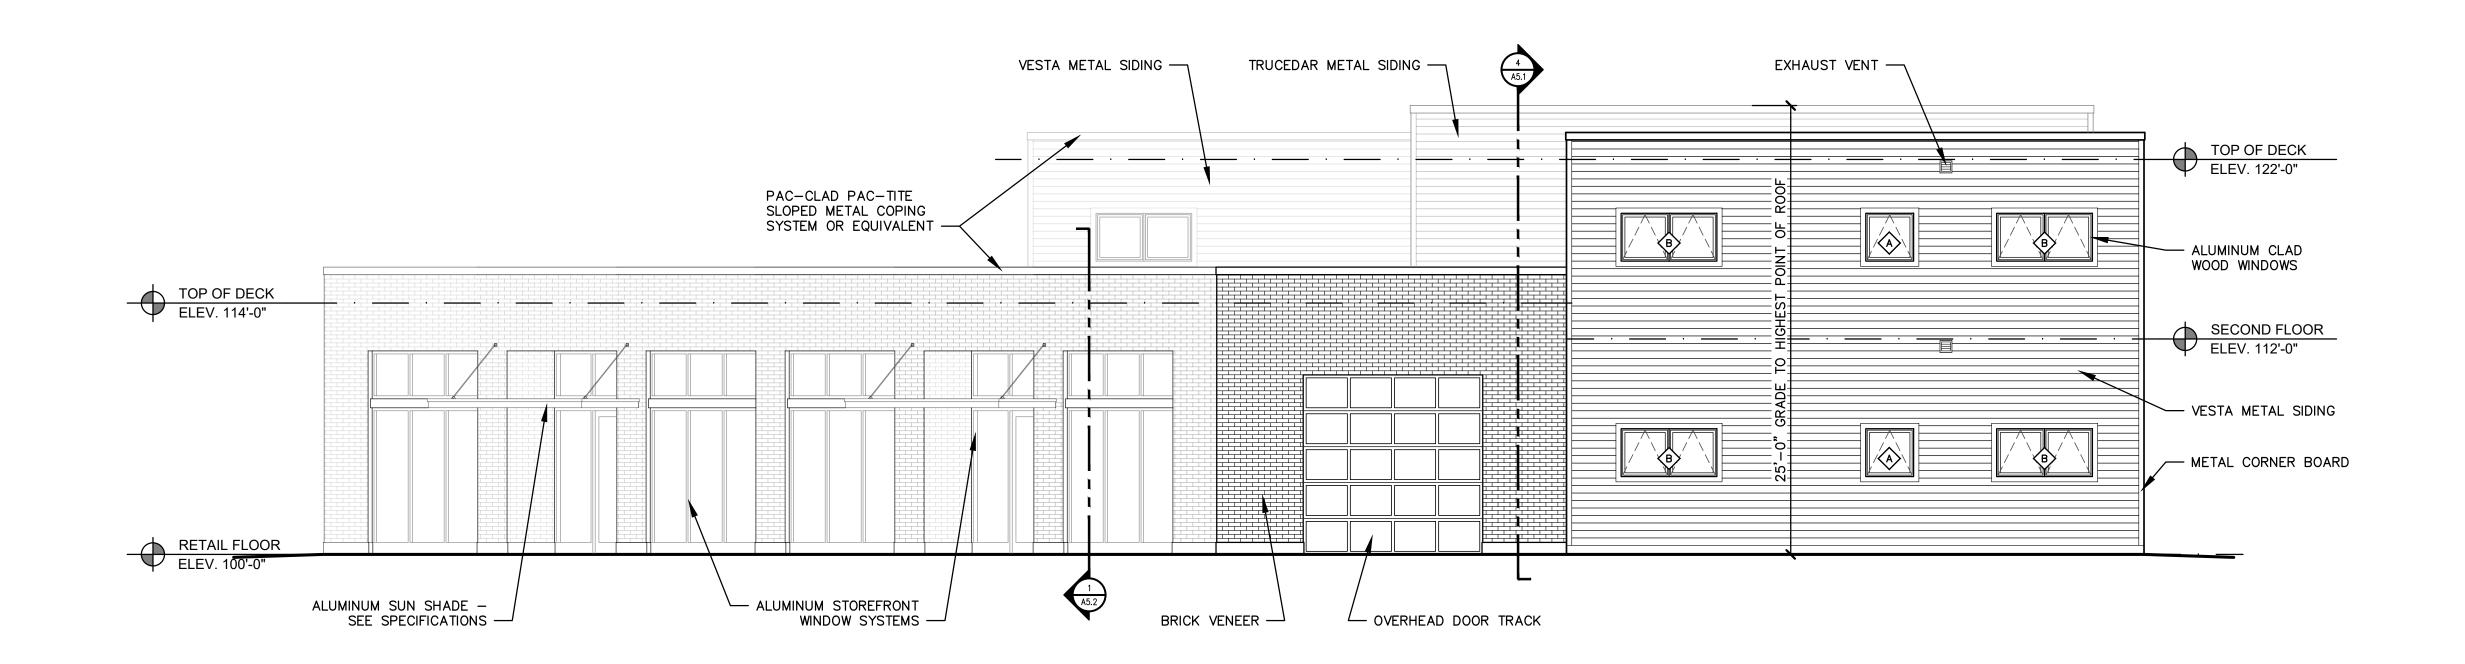
drawing date
FINAL SPR SUBMITTAL
06.10.2022

sheet number

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quare S C

Eastside Squa Building C

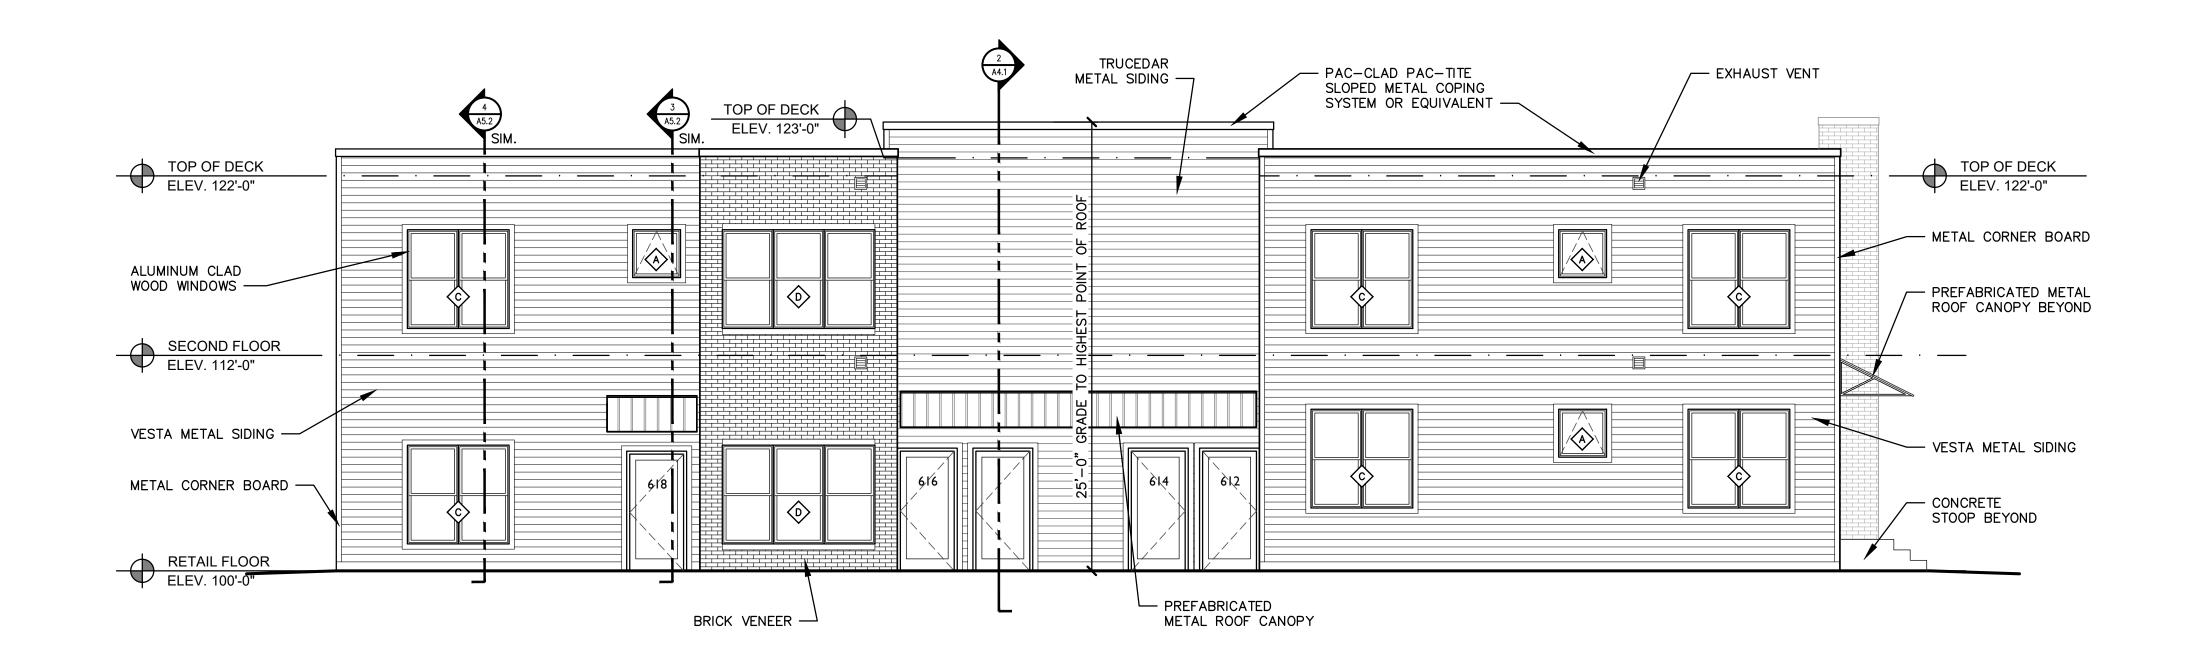sheet name

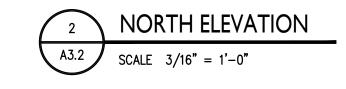EXTERIOR ELEVATIONS


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21003

drawing date
FINAL SPR SUBMITTAL
06.10.2022

sheet number

A3.2C



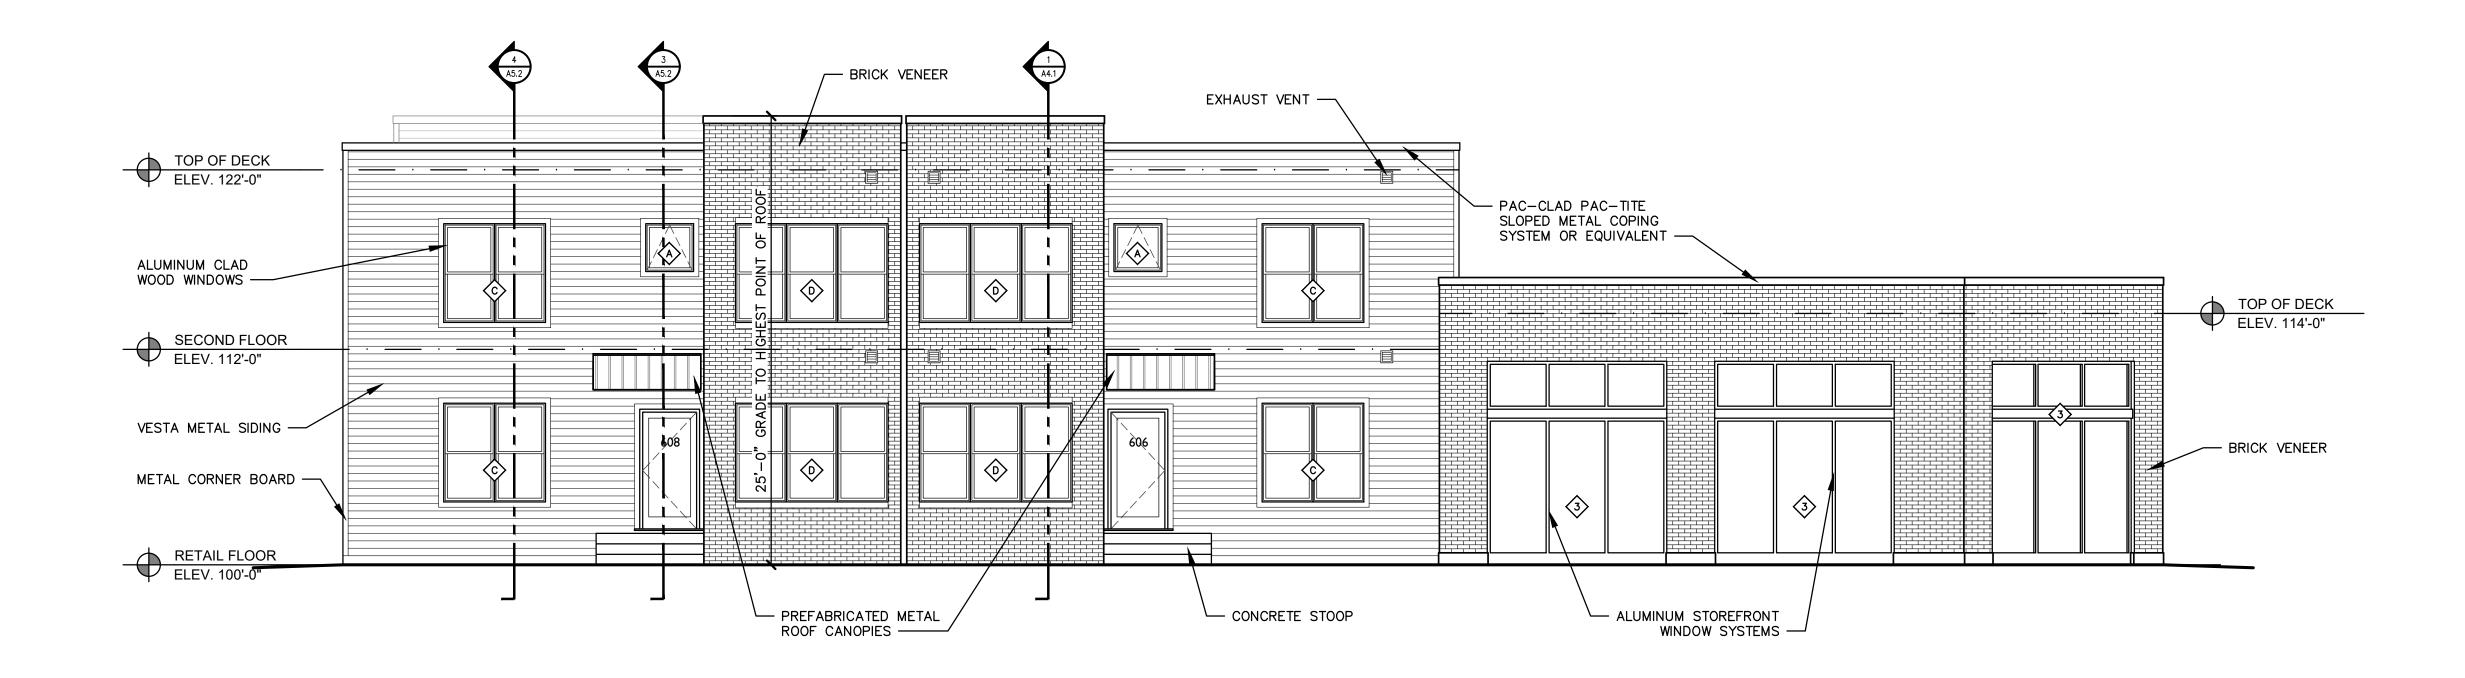

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New Construction:

tside Square

sheet name

EXTERIOR ELEVATIONS

project number

21003

drawing date
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06.10.2022

sheet number

A3.3C

Eastside Square

Building C - Zoning Compliance Information

2022.06.10

Proposed Property addresses

1601 East Main612 Southworth Terrace1603 East Main614 Southworth Terrace606 Southworth Terrace616 Southworth Terrace608 Southworth Terrace618 Southworth Terrace

Item	Required/Allowed	Proposed
Zoning		
Zoning	Live-Work 2 (LW2)	Live-Work 2 (LW2)
Lot Type		Flex
Street Frontage		
Multiple Principal Buildings permitted	Permitted	Not proposed
Front lot line coverage (min) along East Main	70%	81' Building + 28' Courtyard =
Occupation of Corner	Required	Yes - to vision setback
Front Built-to Zone	0-10'	0' @ East Main, 4'-7' @ Southworth
Corner Build-to Zone	0-10'	1' from vision clearance line
ROW encroachment	Permitted	Yes - sun screens @ East Main
Lot Area		
Side yard setback	0	23'
Rear yard setback - residential adjacent	10'	72'
Rear yard setback - commercial adjacent	0	NA
Height		
Height	1-3 stories	1 & 2 Stories
Ground floor height	12-24'	16'
Upper floor height	9-14'	10'
Uses		
Ground floor use	Per Table 4-1.1	Commercial General Services or Retail & Residential Multifamily
Lot Coverage		
Impervious surface (max)	75%	75%
Semi-impervious surface	15%	0%

Parking, loading and access		
Parking location	Rear yard	Rear yard
Loading and service location	Rear or side	Rear yard
Driveway location	Alley	Rear - off Southworth
East Main Street Façade		
Entrance Location	Faces Primary Street	East Main
Entrance Treatment		Storefront
Number of Entrances	1 / 60' min	2 entrances for 82' façade
		length - complies
Entrance Recess	8' max	3'
Transparency (min)	70% (2' to 8' above grade)	74%
Corner Façade		
Entrance Location		NA
Entrance Treatment		Storefront
Transparency (min)	70% (2' to 8' above grade)	71%
Southworth Terrace Façade		
Entrance locations		Southworth Terrace
Entrance Treatment		Stoop
Stoop Dimensions	3' deep x 6' wide	3' deep x 6' wide
Stoop Height	4'-6" max	24"
Number of Entrances	1 / 60' min	2 entrances for 90' façade
		length - complies
Transparency (min)	50% (2' to 8' above grade)	52%
Roof Type		
Tower	Permitted	No
Spire	Not Permitted	No